#### 100361-PGE TRANSMISSION POLES AT 124TH/TSR-M3252958



### GENERAL CONDITIONS For Permits To Work in Washington County Right-of-Way

- 1. Comply with these General Conditions unless otherwise allowed, in writing, or modified by the Special Conditions or Special Provisions contained within this permit.
- 2. This permit does not authorize any activity on privately owned property or public rights-of-way not under the control and jurisdiction of Washington County.
- 3. Failure to comply with any term or condition of this permit shall be cause for the County to revoke, annul, terminate, suspend, revise or amend this permit or issue code violation citation or take any legal action necessary to correct the violation. All costs associated with work stoppage or revocation as provided herein are the responsibility of the Permittee.
- 4. Follow the direction of Washington County if actual site conditions warrant the need to modify any previously approved construction, traffic control, or erosion control plan. Washington County reserves the right to make changes to the permit and approved supplementary documents including any and all plans at any given time. If submitted plans were prepared by an engineer, submit as built plans to Washington County at project completion.
- 5. Obtain County approval prior to modifying the scope of the permitted work.
- 6. Communicate and coordinate, as needed, with adjacent residents, businesses, and other service providers (i.e. utilities, transit providers, garbage haulers, etc.) that may be impacted by the work associated with this permit.
- 7. Comply with all applicable city, county, state and federal laws and regulations associated with the performance of the work authorized by this permit. Laws and regulations listed in these General Conditions or the Special Provisions are for courtesy purposes only. These listings are not intended to be comprehensive. It is the responsibility of the Permittee and those performing the work to be knowledgeable about all applicable laws and regulations.
- 8. Washington County has the authority to designate the location where lines, fixtures and facilities may be located, and subject to ORS 758.025 may order the location of any such line, fixture or facility to be changed when deemed expedient by the County. Any line, fixture or facility erected or remaining in a different location upon such road than that designated in any order of the County is a public nuisance and may be abated accordingly.
- 9. Obtain any other permits, licenses, or authorizations required by other utilities, public agencies, or organizations for performing work authorized under this permit.
- 10. ATTENTION: Oregon law requires you to follow rules adopted by the Oregon Utility Notification Center. Those rules are set forth in OAR 952-001-0010 through OAR 952-001-0100. You may obtain copies of the rules by calling the center. The telephone number for the Oregon Utility Notification Center is (503) 232-1987, (800) 332-2344, or 811. You can also visit www.digsafelyoregon.com for more information. The Oregon Utility Notification Center One Call locates telephone number in the greater Portland Metropolitan area is (503) 246-6699.
- 11. Permittee shall contact the County, using one of the three *Contact Options* below, at least one (1) business day prior to the following milestones:
  - a) Start of construction For notification purposes only. Formal inspection not required to commence construction. Indicate that inspection request is for start of construction.
  - b) Concrete form inspection Concrete shall not be placed until forms have passed formal inspection.
  - c) Pre-paving inspection Paving shall not be performed until site has passed formal inspection.
  - d) A break in construction greater than three (3) days (excluding holidays and weekend) For notification purposes only.
  - e) Completion of construction Use "Final" inspection code to request inspection after all permitted work is complete.

Coordinate with Washington County for inspection and TCP review:

Andrew Davidson 971-348-7667

Coordinate with Washington County and Kerr Contractors for site access and schedule:

Scott Miller Washington County Utility Coordinator 971-708-3042 Andrew Davidson Washington County inspector 971-348-7667 Kacy Carter Kerr Contractors 971-235-5024

13. Construct the permitted activity with materials, equipment, labor, and workmanship to meet or exceed the relevant specifications established in the Washington County Road Design and Construction Standards (Ordinance #738 as adopted January 27, 2011), the 2018 Oregon Standard Specifications for Construction, and any special conditions or provisions established by this permit. Ensure quality control is maintained for all work performed and correct any work that does not meet the minimum standards and specifications.



# GENERAL CONDITIONS For Permits To Work in Washington County Right-of-Way

- 14. Establish and maintain work zone traffic control in compliance with the *Oregon Temporary Traffic Control Handbook for Operations of Three Days or Less* (December 2011) any time vehicle or pedestrian traffic is influenced by the work. For work requiring devices in place longer than three (3) days, a site specific traffic control plan based on the principles in Part 6 of the MUTCD, the Oregon Supplement and ODOT's 2015 Standard Drawings TM800 TM871, is required. All traffic control devices shall meet or exceed the NCHRP 350 requirements for crashworthiness. Completed signal shut down requests must be received by the County a minimum of 3 working days prior to any proposed signal shut down.
- 15. Accommodate all road users at all times including motorists, bicyclists, pedestrians, and those with disabilities or impairments. Install and maintain additional temporary signing and traffic control devices for the control of non-motorized vehicles and pedestrians where a reasonable volume of these users are expected and where work is expected to last longer than one hour. Maintain safe accessibility or provide suitable alternate routes in, through, or around work areas.
- 16. Limit work & activity (construction, restoration, erosion control, etc) to no more than 1,000 lineal feet at any one time.
- 17. Impact no more than one consecutive intersection at a time.
- 18. Do not store or park any equipment, vehicles, or materials in the right-of-way overnight unless approved by Washington County.
- 19. Utilize construction materials and methods to maintain at least one travel lane at all times. Adjust work zone to ensure no vehicles are stopped, held or restricted for more than fifteen (15) minutes. Lane restrictions may be allowed in accordance with an approved traffic control plan and according to the following table:

	Mon - (except on day pro	Day preceding a holiday	
Functional Classification	Earliest Start Time	Latest End Time	Latest End Time
Arterial	9:00 a.m.	3:30 p.m.	
Collector/ Neighborhood Route	8:30 a.m.	4:00 p.m.	12:00 p.m.
Local	8:00 a.m.	5:00 p.m.	

20. Suspend work on the following holidays: New Year's Day (Jan 1), Martin Luther King Day (3rd Mon in Jan), President's Day (3rd Mon in Feb), Memorial Day (last Monday in May), Independence Day (Jul 4), Labor Day (1st Monday in Sept), Veteran's Day (Nov 11) Thanksgiving (4th Thursday & 4th Friday in Nov), Christmas Day (Dec 25).

When a holiday falls on a Saturday, the observed holiday is the preceding Friday. When a holiday falls on a Sunday, the observed holiday is the following Monday.

21. Comply with Washington County's *Best Management Practices for Routine Road Maintenance* (December 2010) as well as Clean Water Services' *Erosion Prevention and Sediment Control Standards* and the appropriate best management practices outlined in Clean Water Services' *Design and Construction Standards*.

Ensure all equipment is clean and leak free with sufficient and appropriate spill prevention and clean up materials on site and the personnel involved with the permitted activity are familiar with and proficient in the use of these materials. When not being actively used for the permitted activity, remove construction equipment from the right-of-way. Do not park, refuel, or service equipment or store hazardous materials directly over or uphill from catch basins, drainage inlets, or manholes or within 150 feet of any wetland, waterway, or resource water. When reasonably available, re-fuel over an impervious surface and use absorbent pads to collect spilled fuel.

Install and <u>maintain</u> appropriate erosion and sediment control devices, in accordance with an approved Erosion and Sediment Control Plan (ESCP) to ensure that all catch basins, drainage inlets, manholes, wetlands, waterways, and resource waters are sufficiently protected from erosion and sediment. In the absence of a formal ESCP, comply with Clean Water Services' *Erosion Prevention and Sediment Control* Standards.


- 22. Preserve and protect all public and private infrastructure ensuring that these facilities continue to properly function during the course of the permitted activity, including, but not limited to, underground storm drainage systems, open drainage systems, culverts, roof drains, field inlets and drains, irrigation systems, traffic control devices, and illumination.
- 23. Restore all existing infrastructure, affected by the permit activity, to original or better condition. Restoration includes, but is not limited to, the road surface, base and subgrade, pavement markings, drainage facilities, signs, safety appurtenances, bicycle and pedestrian facilities, vegetation or landscaping and any other feature affected by the activity. Restoration of the right-of-way shall be completed in a timely manner and to the County's satisfaction.
- 24. Re-establish surfaces to their pre-existing grade at the end of each work day. For Asphaltic surfaces or Portland cement concrete, interim re-establishment shall be with either hot mix or cold mix asphaltic concrete and shall be in place for no longer than fourteen (14) calendar days. Beyond fourteen (14) calendar days, permanent right-of-way restoration shall be used unless approved by the County. STEEL PLATES are NOT an acceptable interim solution unless prior approval has been obtained through Washington County.



# GENERAL CONDITIONS For Permits To Work in Washington County Right-of-Way

- 25. Installation of underground utilities or any other buried appurtenance shall be at least thirty (30) inches below grade. All mechanically extracted, cylindrical cores, up to 8" diameter, taken from the paved section of roadway shall be restored according to the County's "Core Hole" Detail.
- 26. Concrete panels shall not be cut without express written permission from Washington County. If concrete panels, curbs, sidewalks or driveways are disturbed or damaged, replacement of full panels, to the nearest cold joint, shall be required. Prior to pouring concrete. Permittee shall submit concrete mix design for review and approval by Washington County and arrange for a form inspection.
- 27. Preserve and protect survey monuments, public land corners and any accessory associated with these features. If interference, removal, or destruction is necessary, comply with ORS 209.140 through ORS 209.155. Additionally, utility infrastructure may not be placed within one foot of a survey monument location noted on a subdivision or partition plat, in accordance with ORS 92.044. The Washington County Surveyor can be reached at (503) 846-8723.
- 28. Comply with Washington County's Noise Control Ordinance established in Chapter 8.24 of the County's *Code of Ordinances*. Acquire a variance to the noise ordinance, when needed.
- 29. Interaction with the County, other agencies, service providers and the public shall be in a professional, courteous and timely manner.
- 30. Maintain a complete set of the permit, approved plans, traffic control plans, erosion control plans, and any conditions or special provisions at the job site and have them available for review, upon request.
- 31. Grant the County immediate access to the permitted work area. The Permittee shall appoint and assign a foreman or competent person that shall be available as the County's point of contact while work is being performed. If this foreman or competent person is unavailable while work is being performed, the Permittee shall provide the County with an alternate. The County reserves the right to enter the work area covered under this permit for any reason.
- 32. Permits are valid for one year from date of issuance and all work must be completed in that time period. Expired permits, without an approved final inspection, may have a notice placed in their property record related to the permit status.
- 33. If the requirements for this permit have not been met, there may be a denial or delay with the issuance of other permits.
- 34. Guarantee all permitted work for a minimum of one year from date of completion. County may require a cash deposit during the guarantee period depending on the type of work. In the event that the Permittee fails to perform warranty work in a timely manner to the satisfaction of Washington County, the deficient work may be corrected, mitigated, or abated by the County. Permittee shall be responsible for all expenses associated with work done by the County to correct, mitigate, or abate a deficiency.
- 35. Additional fees may be required if there is a substantial change in the scope of work which requires further review by Washington County or if more than three site visits are needed for inspection purposes. Additional inspection fees will be charged in accordance with the adopted fee schedule.
- 36. Include the permit number in all written and verbal correspondence with the County.
- 37. Comply with the Right-of-Way Permit Insurance Requirements (i.e. Tier 1, Tier 2, or Tier 3) determined for this permit.

PERMIT APPROVAL

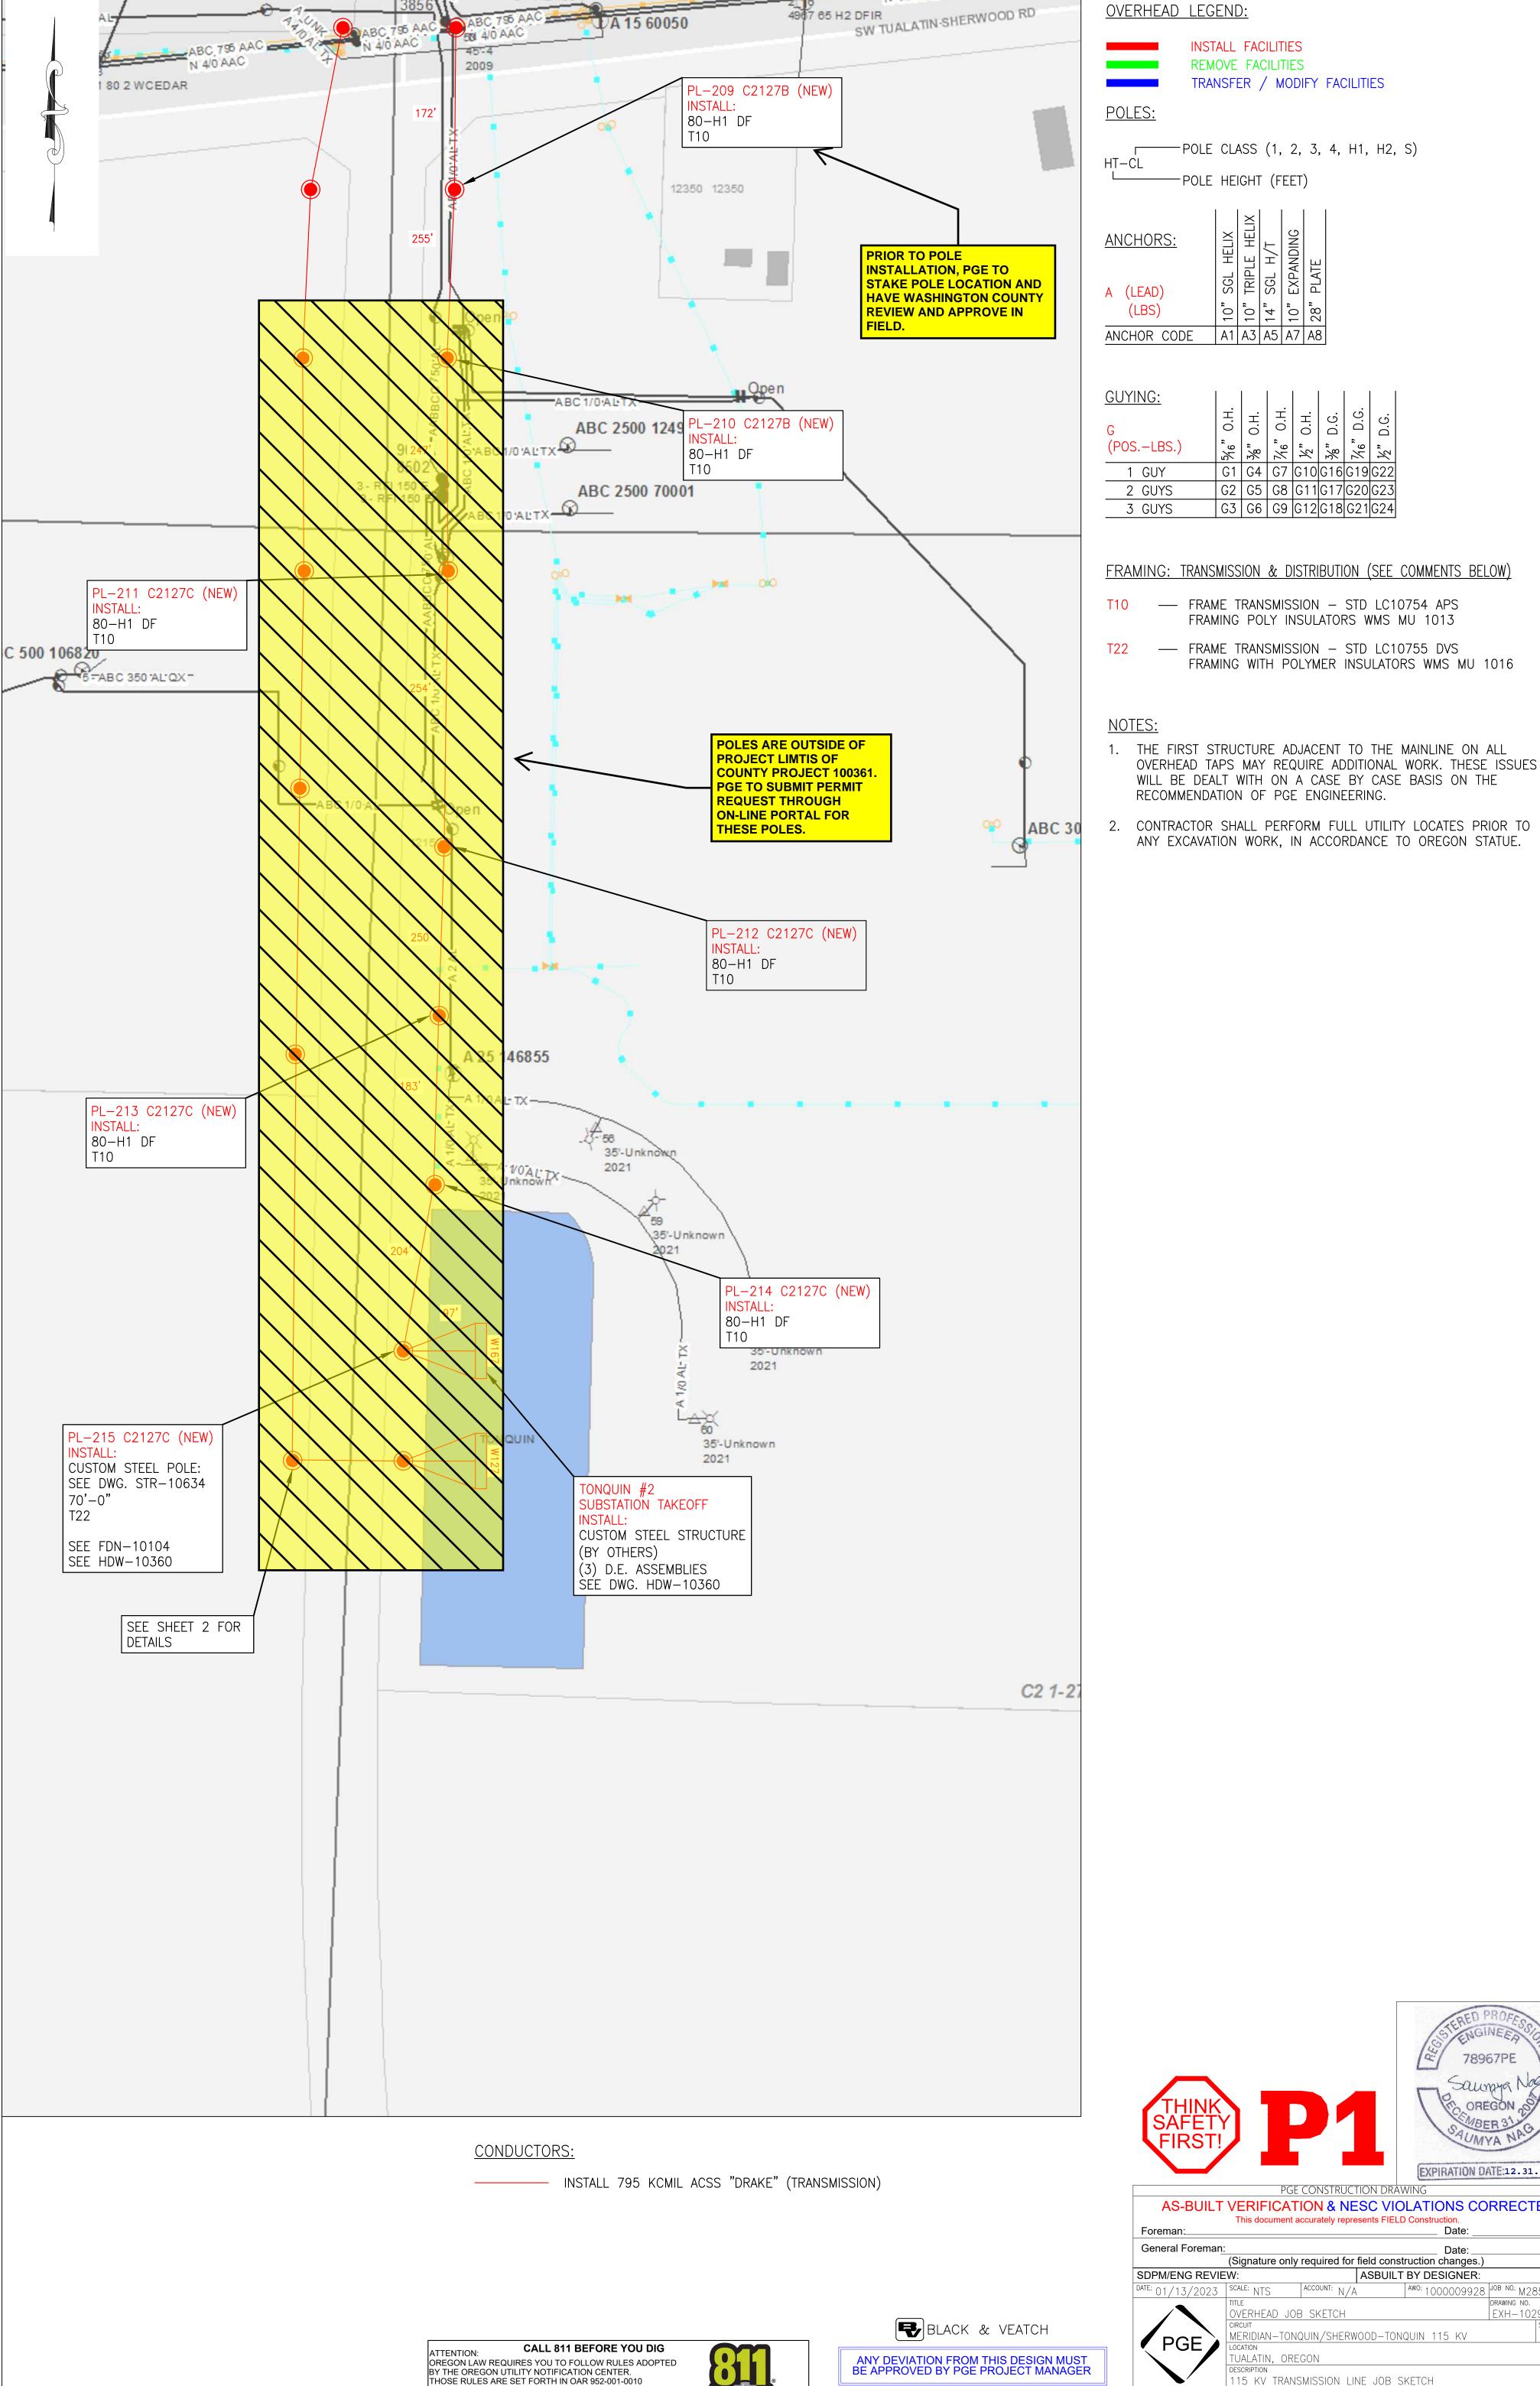

THROUGH 952-001-0090. YOU MAY OBTAIN COPIES OF

TO REQUEST UTILITY LOCATES CALL THE OREGON

UTILITY NOTIFICATION CENTER, 811 AT LEAST 2 BUSINESS DAYS PRIOR TO EXCAVATION.

NOTIFICATION CENTER ADMINISTRATION @ (503-232-1987)

THE RULES BY CALLING THE OREGON UTILITY

3 - 142 100 T

EXPIRATION DATE:12.31.2024 **AS-BUILT VERIFICATION & NESC VIOLATIONS CORRECTED** This document accurately represents FIELD Construction. Date: (Signature only required for field construction changes.) ASBUILT BY DESIGNER: AWO: 1000009928 JOB NO. M2851163 DRAWING NO. EXH-10292 MERIDIAN-TONQUIN/SHERWOOD-TONQUIN 115 KV 115 KV TRANSMISSION LINE JOB SKETCH SECTION(S) M2851163 **1 OF 4** 

© PORTLAND GENERAL ELECTRIC CO. - ALL RIGHTS RESERVED

(913)458-9284 BLACK & VEATCH REV 1

TRANSMISSION

ENGINEERING

3700 SE 17TH AVE

DESIGN BY

ALLYSE PAGANO

TJP

TJP

ARP

ARP

EKS

EKS


1 01/18/23 ISSUE FOR CONSTRUCTION

0 01/13/23 ISSUE FOR CONSTRUCTION

REVISION AND RECORD OF ISSUE

Know what's **below.** 

Call before you dig. NO. DATE

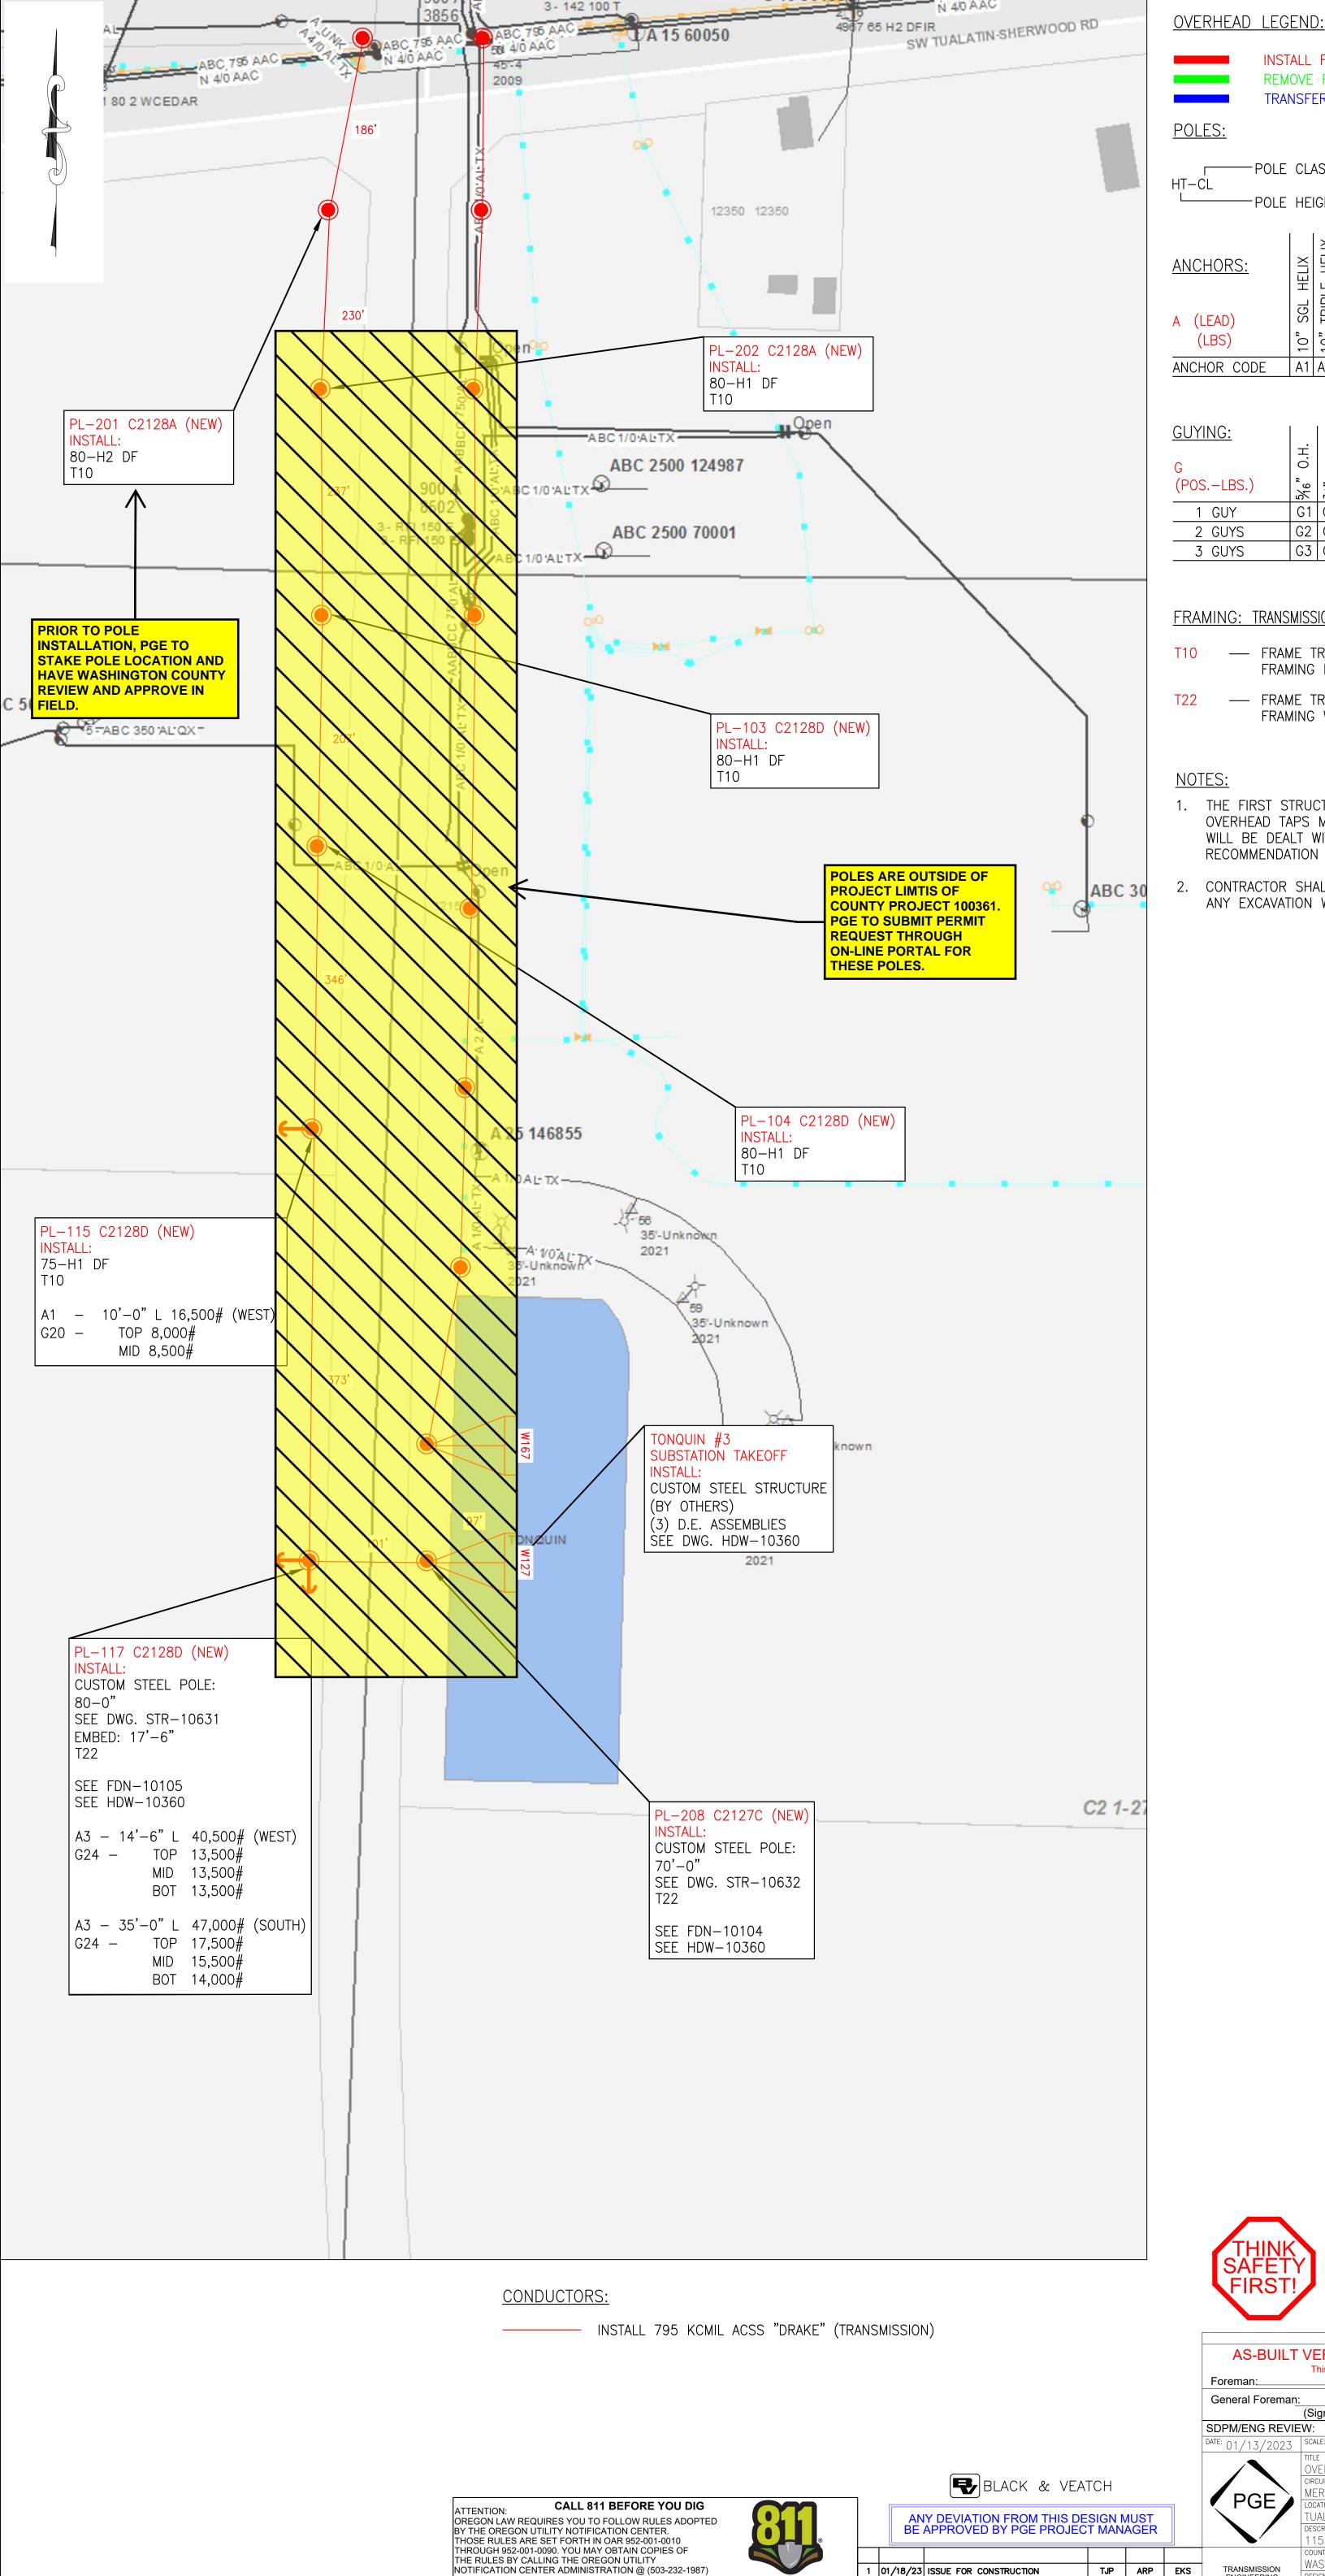

TO REQUEST UTILITY LOCATES CALL THE OREGON

UTILITY NOTIFICATION CENTER, 811 AT LEAST 2 BUSINESS DAYS PRIOR TO EXCAVATION.

INSTALL FACILITIES REMOVE FACILITIES TRANSFER / MODIFY FACILITIES POLES:

—POLE CLASS (1, 2, 3, 4, H1, H2, S) HT-CL

-POLE HEIGHT (FEET)

SGL HELIX
TRIPLE HELIX
SGL H/T
EXPANDING
PLATE **ANCHORS:** A (LEAD) 10" 10" 14" 28" (LBS) A1 A3 A5 A7 A8 ANCHOR CODE

**GUYING:** 7/6" О.Н. ½" О.Н. 3/8" D.G. 7/6" D.G. ½" D.G. О. Н. %" %" (POS.-LBS.) G1 G4 G7 G10 G16 G19 G22 1 GUY G2 G5 G8 G11G17G20G23 2 GUYS G3 G6 G9 G12 G18 G21 G24 3 GUYS

### FRAMING: TRANSMISSION & DISTRIBUTION (SEE COMMENTS BELOW)


- FRAME TRANSMISSION - STD LC10754 APS FRAMING POLY INSULATORS WMS MU 1013

- FRAME TRANSMISSION - STD LC10755 DVS FRAMING WITH POLYMER INSULATORS WMS MU 1016

### NOTES:

- 1. THE FIRST STRUCTURE ADJACENT TO THE MAINLINE ON ALL OVERHEAD TAPS MAY REQUIRE ADDITIONAL WORK. THESE ISSUES WILL BE DEALT WITH ON A CASE BY CASE BASIS ON THE RECOMMENDATION OF PGE ENGINEERING.
- 2. CONTRACTOR SHALL PERFORM FULL UTILITY LOCATES PRIOR TO ANY EXCAVATION WORK, IN ACCORDANCE TO OREGON STATUE.



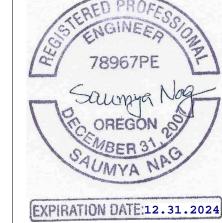

PGE CONSTRUCTION DRÁWING AS-BUILT VERIFICATION & NESC VIOLATIONS CORRECTED This document accurately represents FIELD Construction. Foreman:

General Foreman: (Signature only required for field construction changes.) SDPM/ENG REVIEW: ASBUILT BY DESIGNER: ACCOUNT: N/A DATE: 01/13/2023 | SCALE: NTS AWO: 1000009928 JOB NO. M2581163 OVERHEAD JOB SKETCH EXH-10292 MERIDIAN-TONQUIN/SHERWOOD-TONQUIN 115 KV **PGE** LOCATION

TUALATIN, OREGON 115 KV TRANSMISSION LINE JOB SKETCH SECTION(S) DRAWN BY


TJP ARP EKS TJP ARP EKS

1 01/18/23 ISSUE FOR CONSTRUCTION 0 01/13/23 ISSUE FOR CONSTRUCTION

Know what's **below.** Call before you dig. NO. DATE REVISION AND RECORD OF ISSUE DES

TRANSMISSION ENGINEERING 3700 SE 17TH AVE

DESIGN BY ALLYSE PAGANO (913)458-9284 BLACK & VEATCH | **REV 1** © PORTLAND GENERAL ELECTRIC CO. - ALL RIGHTS RESERVED

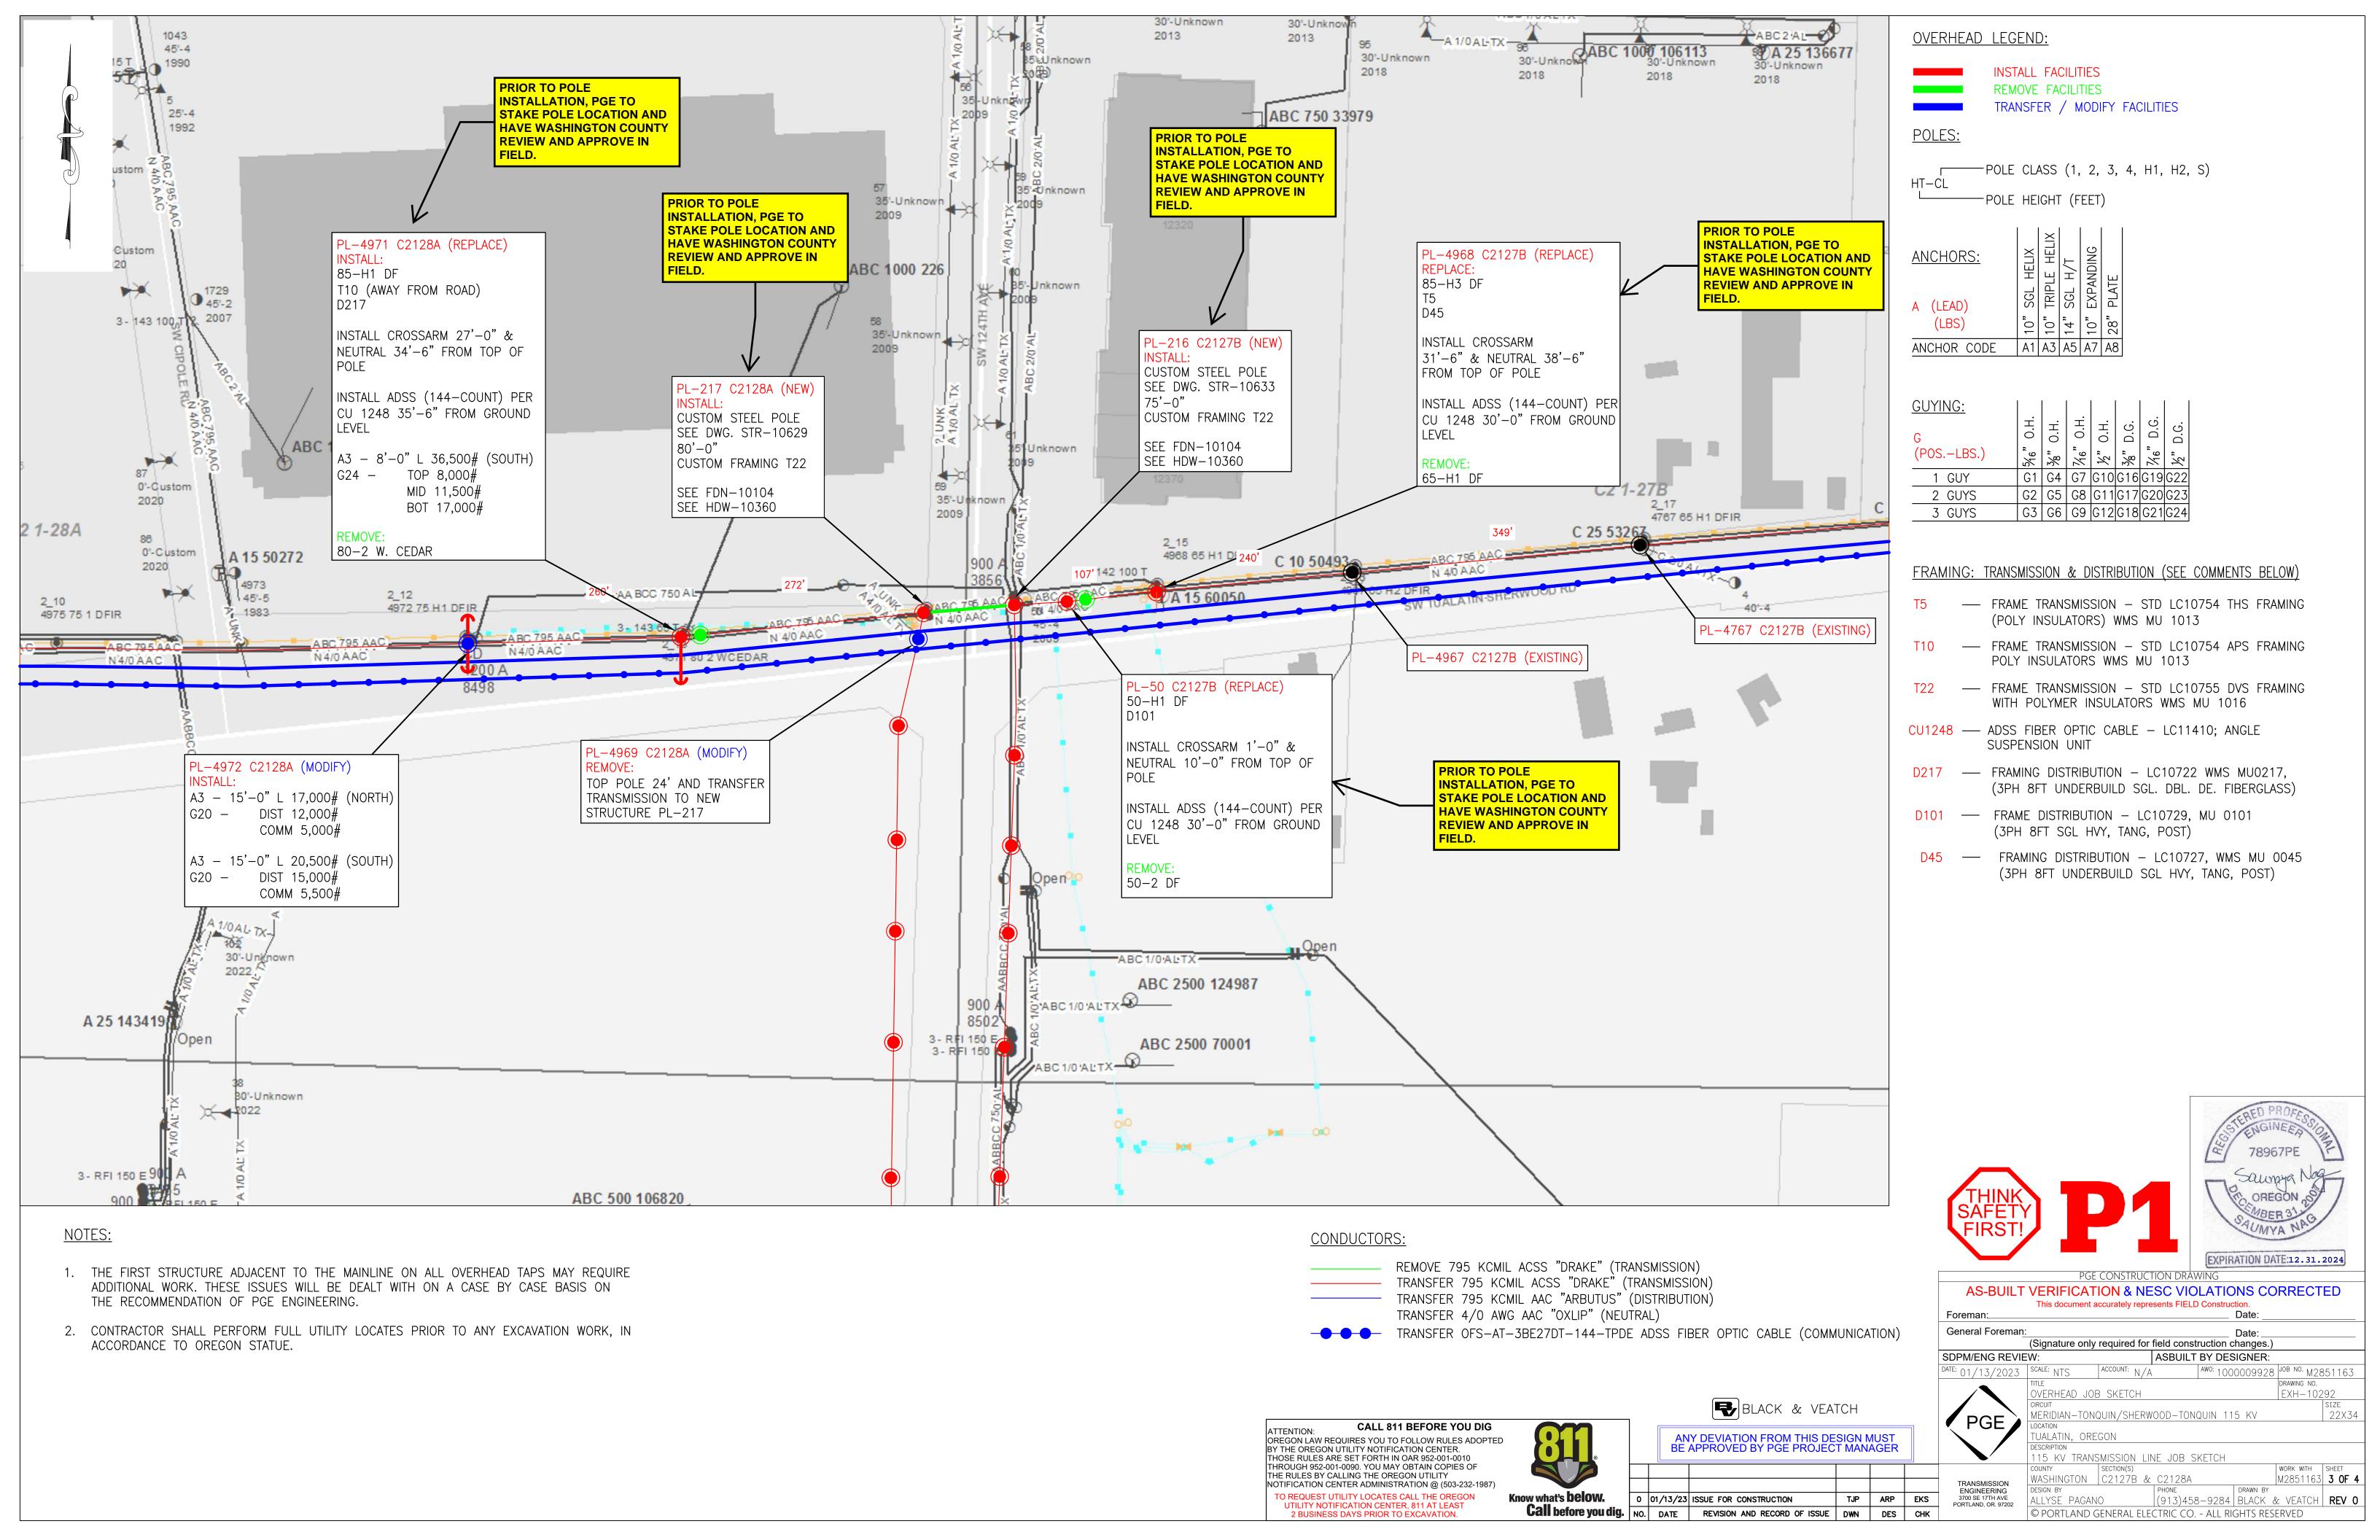

SHERWOOD-TONQUIN 115 KV TRANSMISSION LINE								
	SAG DATA FOR D.E. SECTION: 217 C2128A - 117 C2128D							
	RULING SPAN: 291'-0"							
	795 KCMIL ACSS 'DRAKE' DESIGN TENSION: 5000# @ NESC 250B INITIAL							
SPAN LENGTH (FT)		172'-9"	229'-6"	237'-7"	206'-10"	346'-1"	372'-8"	
AMBIENT AIR	HORIZONTAL TENSION	VERTICAL SAG						
TEMPERATURE (°F)	(LBS.)	217 C2128A - 201	201 C2128A - 202	202 C2128A - 203	203 C2128D - 104	104 C2128D - 115	115 C2128D - 117	
	(LB3.)	C2128A	C2128A	C2128D	C2128D	C2128D	C2128D	

2'-1"

2'-2"

2'-4"

2'-6"

2'-8"

2'-10"

3'-0"

3'-5"

1'-7"

1'-8"

1'-9"

1'-11"

2'-0"

2'-1"

2'-3"

2'-7"

4'-4"

4'-8"

5'-0"

5'-3"

5'-7"

6'-0"

6'-3"

7'-4"

1'-11"

2'-0"

2'-2"

2'-4"

2'-6"

2'-7"

2'-9"

3'-3"

3752

3523

3307

3105

2925

2755

2605

2235

40

50

60

70

80

90

120

1'-1"

1'-2"

1'-3"

1'-4"

1'-5"

1'-6"

1'-7"

1'-10"

	SHERWOOD-TONQUIN 115 KV TRANSMISSION LINE								
	SAG DATA FOR D.E. SECTION: 117 C2128D - 208 C2127C								
]	RULING SPAN: 99'-11"								
	795 KCMIL ACSS 'DRAK	E' DESIGN TENSION: 2000	# @ NESC 250B INITIAL						
]	SPAN LEN	NGTH (FT)	100'-1"						
	AMBIENT AIR TEMPERATURE (°F)	HORIZONTAL TENSION (LBS.)	VERTICAL SAG 117 C2128D - 208 C2127C						
1	30	1208	1'-2"						
1	40	1094	1'-3"						
	50	1000	1'-4"						
	60	925	1'-6"						
	70	863	1'-7"						
	80	811	1'-8"						
	90	765	1'-10"						
	120	670	2'-1"						

5'-1"

5'-5"

5'-9"

6'-1"

6'-6"

6'-11"

7'-3"

8'-6"

SHERWOOD-TONQUIN 115 KV TRANSMISSION LINE					
SAG DATA FOR D.	E. SECTION: 208 C2127C	- TONQUIN SUB #2			
	RULING SPAN: 95'-4"				
795 KCMIL ACSS 'DRAKE	E' DESIGN TENSION: 2000	D# @ NESC 250B INITIAL			
SPAN LEN	NGTH (FT)	96'-8"			
AMBIENT AIR TEMPERATURE (°F)	HORIZONTAL TENSION (LBS.)	VERTICAL SAG 208 C2127C - TONQUIN SUB #2			
30	1215	1'-1"			
40	1089	1'-2"			
50	991	1'-4"			
60	913	1'-5"			
70	847	1'-6"			
80	793	1'-8"			
90	747	1'-9"			
120	652	2'-0"			

MERIDIAN-TONQUIN 115 KV TRANSMISSION LINE								
	SAG DATA FOR D.E. SECTION: 216 C2127B - 215 C2127C							
	RULING SPAN: 229'-8"							
			795 KCMIL ACSS 'DRAKE	DESIGN TENSION: 5000	# @ NESC 250B INITIAL			
SPAN LEN	NGTH (FT)	155'-0"	155'-0" 254'-7" 246'-11" 253'-7"		253'-7"	249'-9"	183'-2"	203'-4"
A MOLENIT A LD	HODIZONITAL TENCION	VERTICAL SAG	VERTICAL SAG	VERTICAL SAG	VERTICAL SAG	VERTICAL SAG	VERTICAL SAG	VERTICAL SAG
AMBIENT AIR	HORIZONTAL TENSION (LBS.)	216 C2127B - 209	209 C2127B - 210	210 C2127B - 211	211 C2127C - 212	212 C2127C - 213	213 C2127C - 214	214 C2127C - 215
TEMPERATURE (°F)		C2127B	C2127B	C2127C	C2127C	C2127C	C2127C	C2127C
30	3935	0'-10"	2'-3"	2'-1"	2'-3"	2'-2"	1'-2"	1'-5"
40	3650	0'-11"	2'-5"	2'-3"	2'-5"	2'-4"	1'-3"	1'-7"
50	3380	1'-0"	2'-7"	2'-6"	2'-7"	2'-6"	1'-4"	1'-8"
60	3122	1'-1"	2'-10"	2'-8"	2'-10"	2'-9"	1'-6"	1'-10"
70	2885	1'-2"	3'-1"	2'-11"	3'-1"	3'-0"	1'-7"	2'-0"
80	2675	1'-3"	3'-4"	3'-1"	3'-3"	3'-2"	1'-9"	2'-1"
90	2480	1'-4"	3'-7"	3'-4"	3'-7"	3'-5"	1'-10"	2'-3"
120	2030	1'-7"	4'-4"	4'-1"	4'-4"	4'-2"	2'-3"	2'-9"
)								

	MERIDIAN-TONQUIN 115 KV TRANSMISSION LINE							
	SAG DATA FOR D.E. SECTION: 215 C2127C - TONQUIN SUB #3							
	RULING SPAN: 94'-10"							
	795 KCMIL ACSS 'DRAKI	E' DESIGN TENSION: 2000	0#@NESC 250BINITIAL					
	SPAN LEN	NGTH (FT)	96'-0"					
	AMBIENT AIR TEMPERATURE (°F)	HORIZONTAL TENSION (LBS.)	VERTICAL SAG 215 C2127C - TONQUIN SUB #3					
	30	1204	1'-1"					
	40	1083	1'-2"					
	50	984	1'-4"					
	60	905	1'-5"					
	70	841	1'-6"					
	80	787	1'-7"					
	90	742	1'-9"					
ı	120	647	2'-0"					



BLACK & VEATCH

M THIS DESIGN MUST E PROJECT MANAGER

TCH SIGN MUST T MANAGER				PGE
	ARP	ARP	EKS	TRANSMISSION

General Foreman:

SDPM/ENG REVIEW:

DATE: 01/13/2023 SCALE: NTS ACCOUNT: N/A

DRAWING NO.

EXH-10292

SIZE

22X34 MERIDIAN-TONQUIN/SHERWOOD-TONQUIN 115 KV TUALATIN, OREGON 115 KV TRANSMISSION LINE STRINGING TABLE COUNTY SECTION(S) WORK WITH SHEET M2851163 4 0F 4 WASHINGTON VARIES (913)458-9284 BLACK & VEATCH REV 1 ALLYSE PAGANO © PORTLAND GENERAL ELECTRIC CO. - ALL RIGHTS RESERVED

PGE CONSTRUCTION DRAWING AS-BUILT VERIFICATION & NESC VIOLATIONS CORRECTED This document accurately represents FIELD Construction.

n: Date: Signature only required for field construction changes.)

EXPIRATION DATE:12.31.2024

AWO: 1000009928 JOB NO. M2851163 DRAWING NO.

\_ Date:

ASBUILT BY DESIGNER:


ED	811.	ANY DEVIATION FROM THIS DESIGN MUST BE APPROVED BY PGE PROJECT MANAGER						
)		1	01/18/23	ISSUE FOR CONSTRUCTION	ARP	ARP	EKS	
	Know what's <b>below.</b>	0	01/13/23	ISSUE FOR CONSTRUCTION	ARP	ARP	EKS	
	<b>Call</b> before you dig.	NO.	DATE	REVISION AND RECORD OF ISSUE	DWN	DES	СНК	

CALL 811 BEFORE YOU DIG

ATTENTION:
OREGON LAW REQUIRES YOU TO FOLLOW RULES ADOPTED
BY THE OREGON UTILITY NOTIFICATION CENTER.
THOSE RULES ARE SET FORTH IN OAR 952-001-0010
THROUGH 952-001-0090. YOU MAY OBTAIN COPIES OF
THE RULES BY CALLING THE OREGON UTILITY
NOTIFICATION CENTER ADMINISTRATION @ (503-232-1987)

TO REQUEST UTILITY LOCATES CALL THE OREGON
UTILITY NOTIFICATION CENTER, 811 AT LEAST
2 BUSINESS DAYS PRIOR TO EXCAVATION.

ATTENTION:

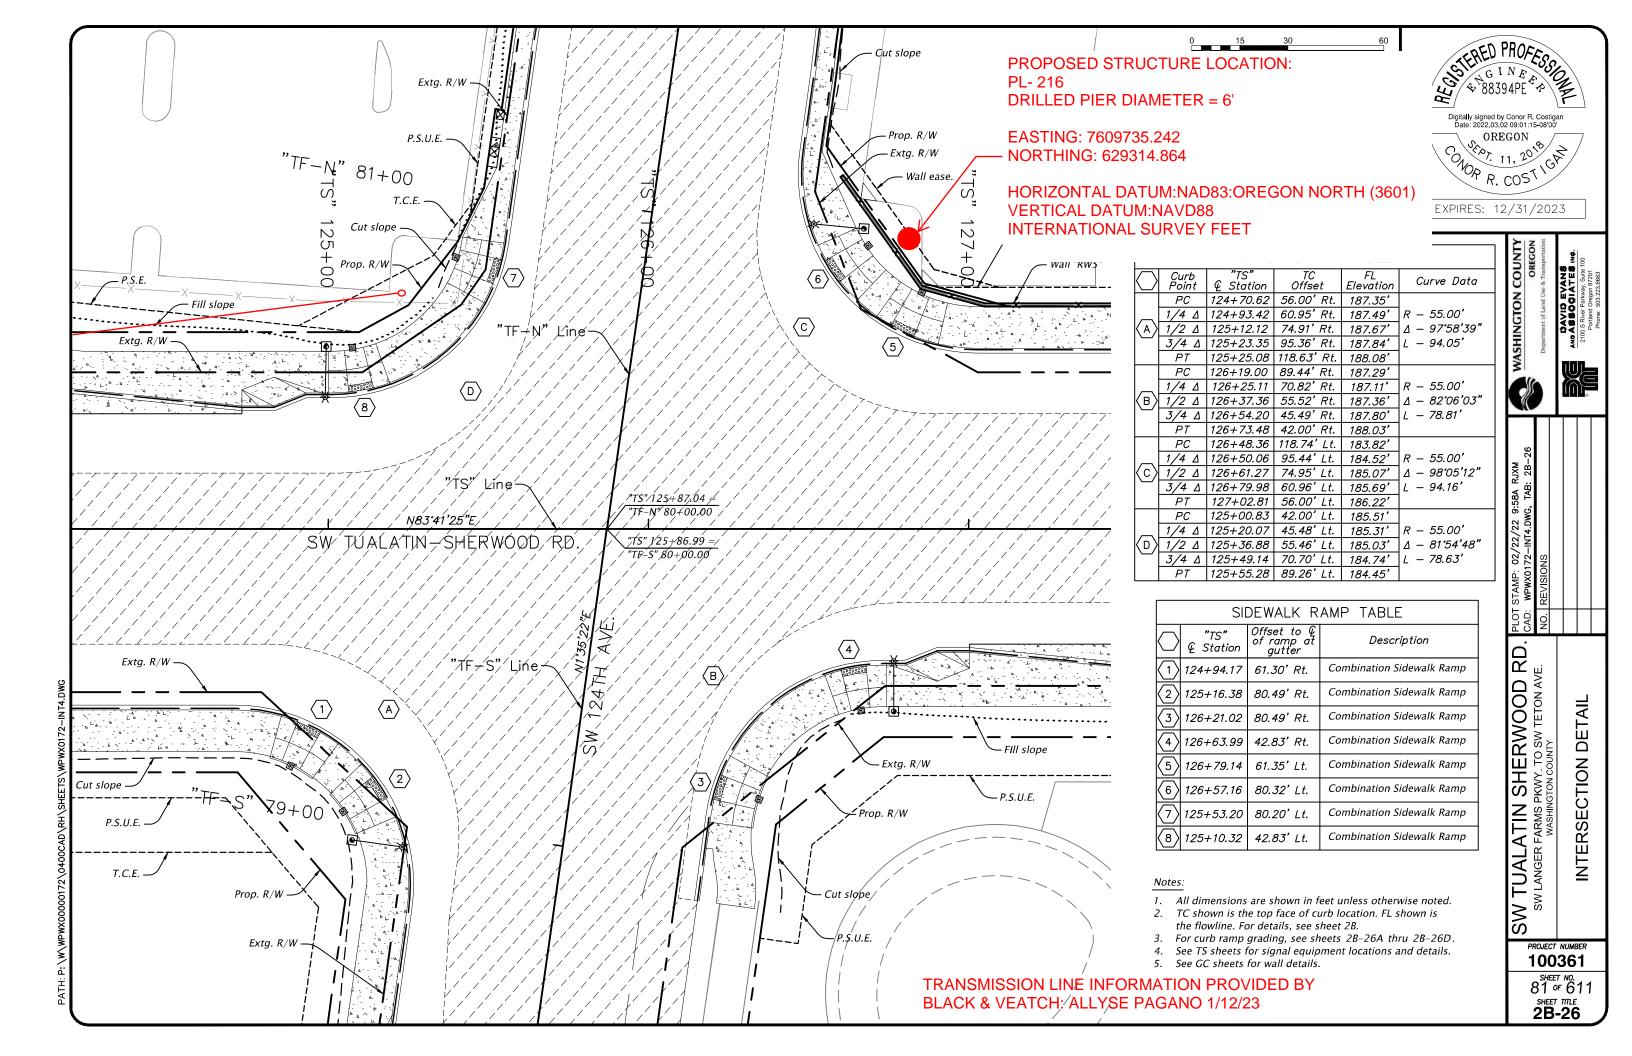



**LEGEND:** 

FACE OF CURB

RIGHT OF WAY/PUE

RIGHT OF WAY

### NOTES:

1. BACKGROUND IMAGE EXTRACTED FROM DIGITAL GLOBE FOR REFERENCE ONLY.

BLACK & VEATCH

OA ISSUE FOR REVIEW

OP/06/22 LSH ARP EKS

REV

DESCRIPTION

DATE DRN DSGN CKD APPD

PGE PERMITTING DRAWINGS

DATE:

OP/06/22 N.T.S. PERMITTING M2764853

TITLE

WASHINGTON COUNTY PERMITTING DRAWING

CIRCUIT

MERIDIAN-SHERWOOD 115 KV TRANSMISSION LINE

ITALATIN, OREGON

COUNTY

SECTION(S)

WASHINGTON

C21-34B, C21-27C

ENGINEER SUPERVISOR
ERIN SWANSON (B&V)

ENGINEER SUPERVISOR
ERIN SWANSON (B&V)

ENGINEER

ALLYSE PAGANO (B&V) (913)-458-9284

BLACK & VEATCH

© PORTLAND GENERAL ELECTRIC CO. - ALL RIGHTS RESERVED

FOR REVIEW

PROFILE VIEW

MERIDIAN—SHERWOOD 115 KV TRANSMISSION LINE
WASHINGTON COUNTY PERMITTING DRAWING

#### **DEVICE SPACING:**


TAPER: 40' RADIUS:10'

TANGENT: 40'



Portland (503) 262-6500

Vancouver (360) 604-5655 (503) 262-0357 Fax (800) 783-9733 **Toll Free** 

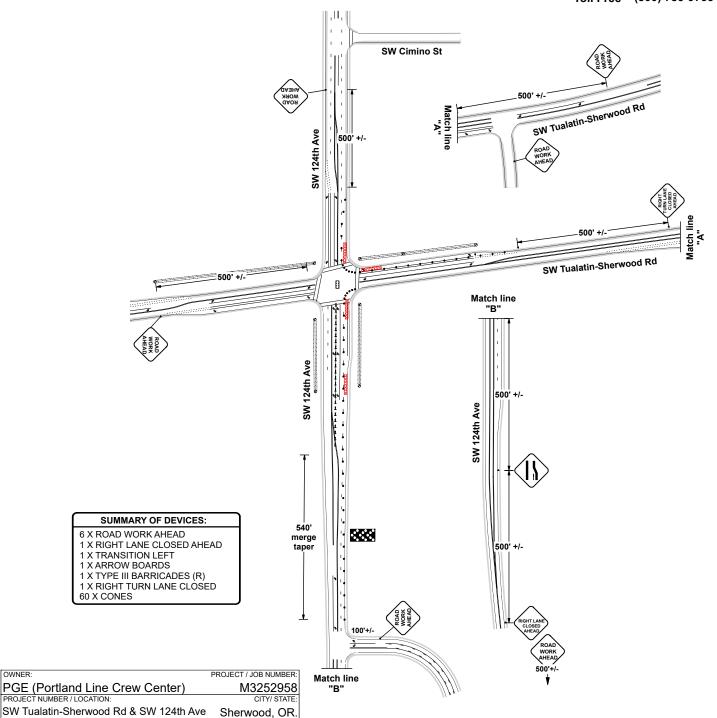

FILE DATE: 12/15/2022

WA Cert # Exp: 04/30/2025

012780

Andy.Brewer@pgn.com TRAFFIC CONTROL CONTRACTOR:

Nathan@nwtci.com

Northwest Traffic Control Inc.

OWNER:

PGE

PROJECT NUMBER / LOCATION

CONTACT NAME / NUMBER: Andy / 503-915-9441 PREPARED BY:

OR Cert # Exp: 11/30/2022

07634

Nathan Burris 503-262-6500

All signs and devices SHALL conform to the MUTCD / OTTCH. Will adjust to fit field conditions. Plan NOT to scale.

