



- Proposed Temporary Circulation Route


Wetland A (Forest Park): 1,074 sq ft; 0.02 ac


1. Root protection zones for single-stem trees are calculated by DBH x 1-ft. Therefore, a 6-in DBH tree has a root protection zone of 6-ft in diameter. For multi-stemmed trees, see Mitigation Site Plan Details II, SHT. L325. Root protection zones are


3. South of the Harborton Substation, only trees with

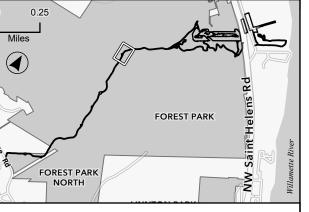


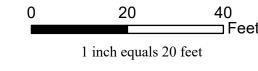


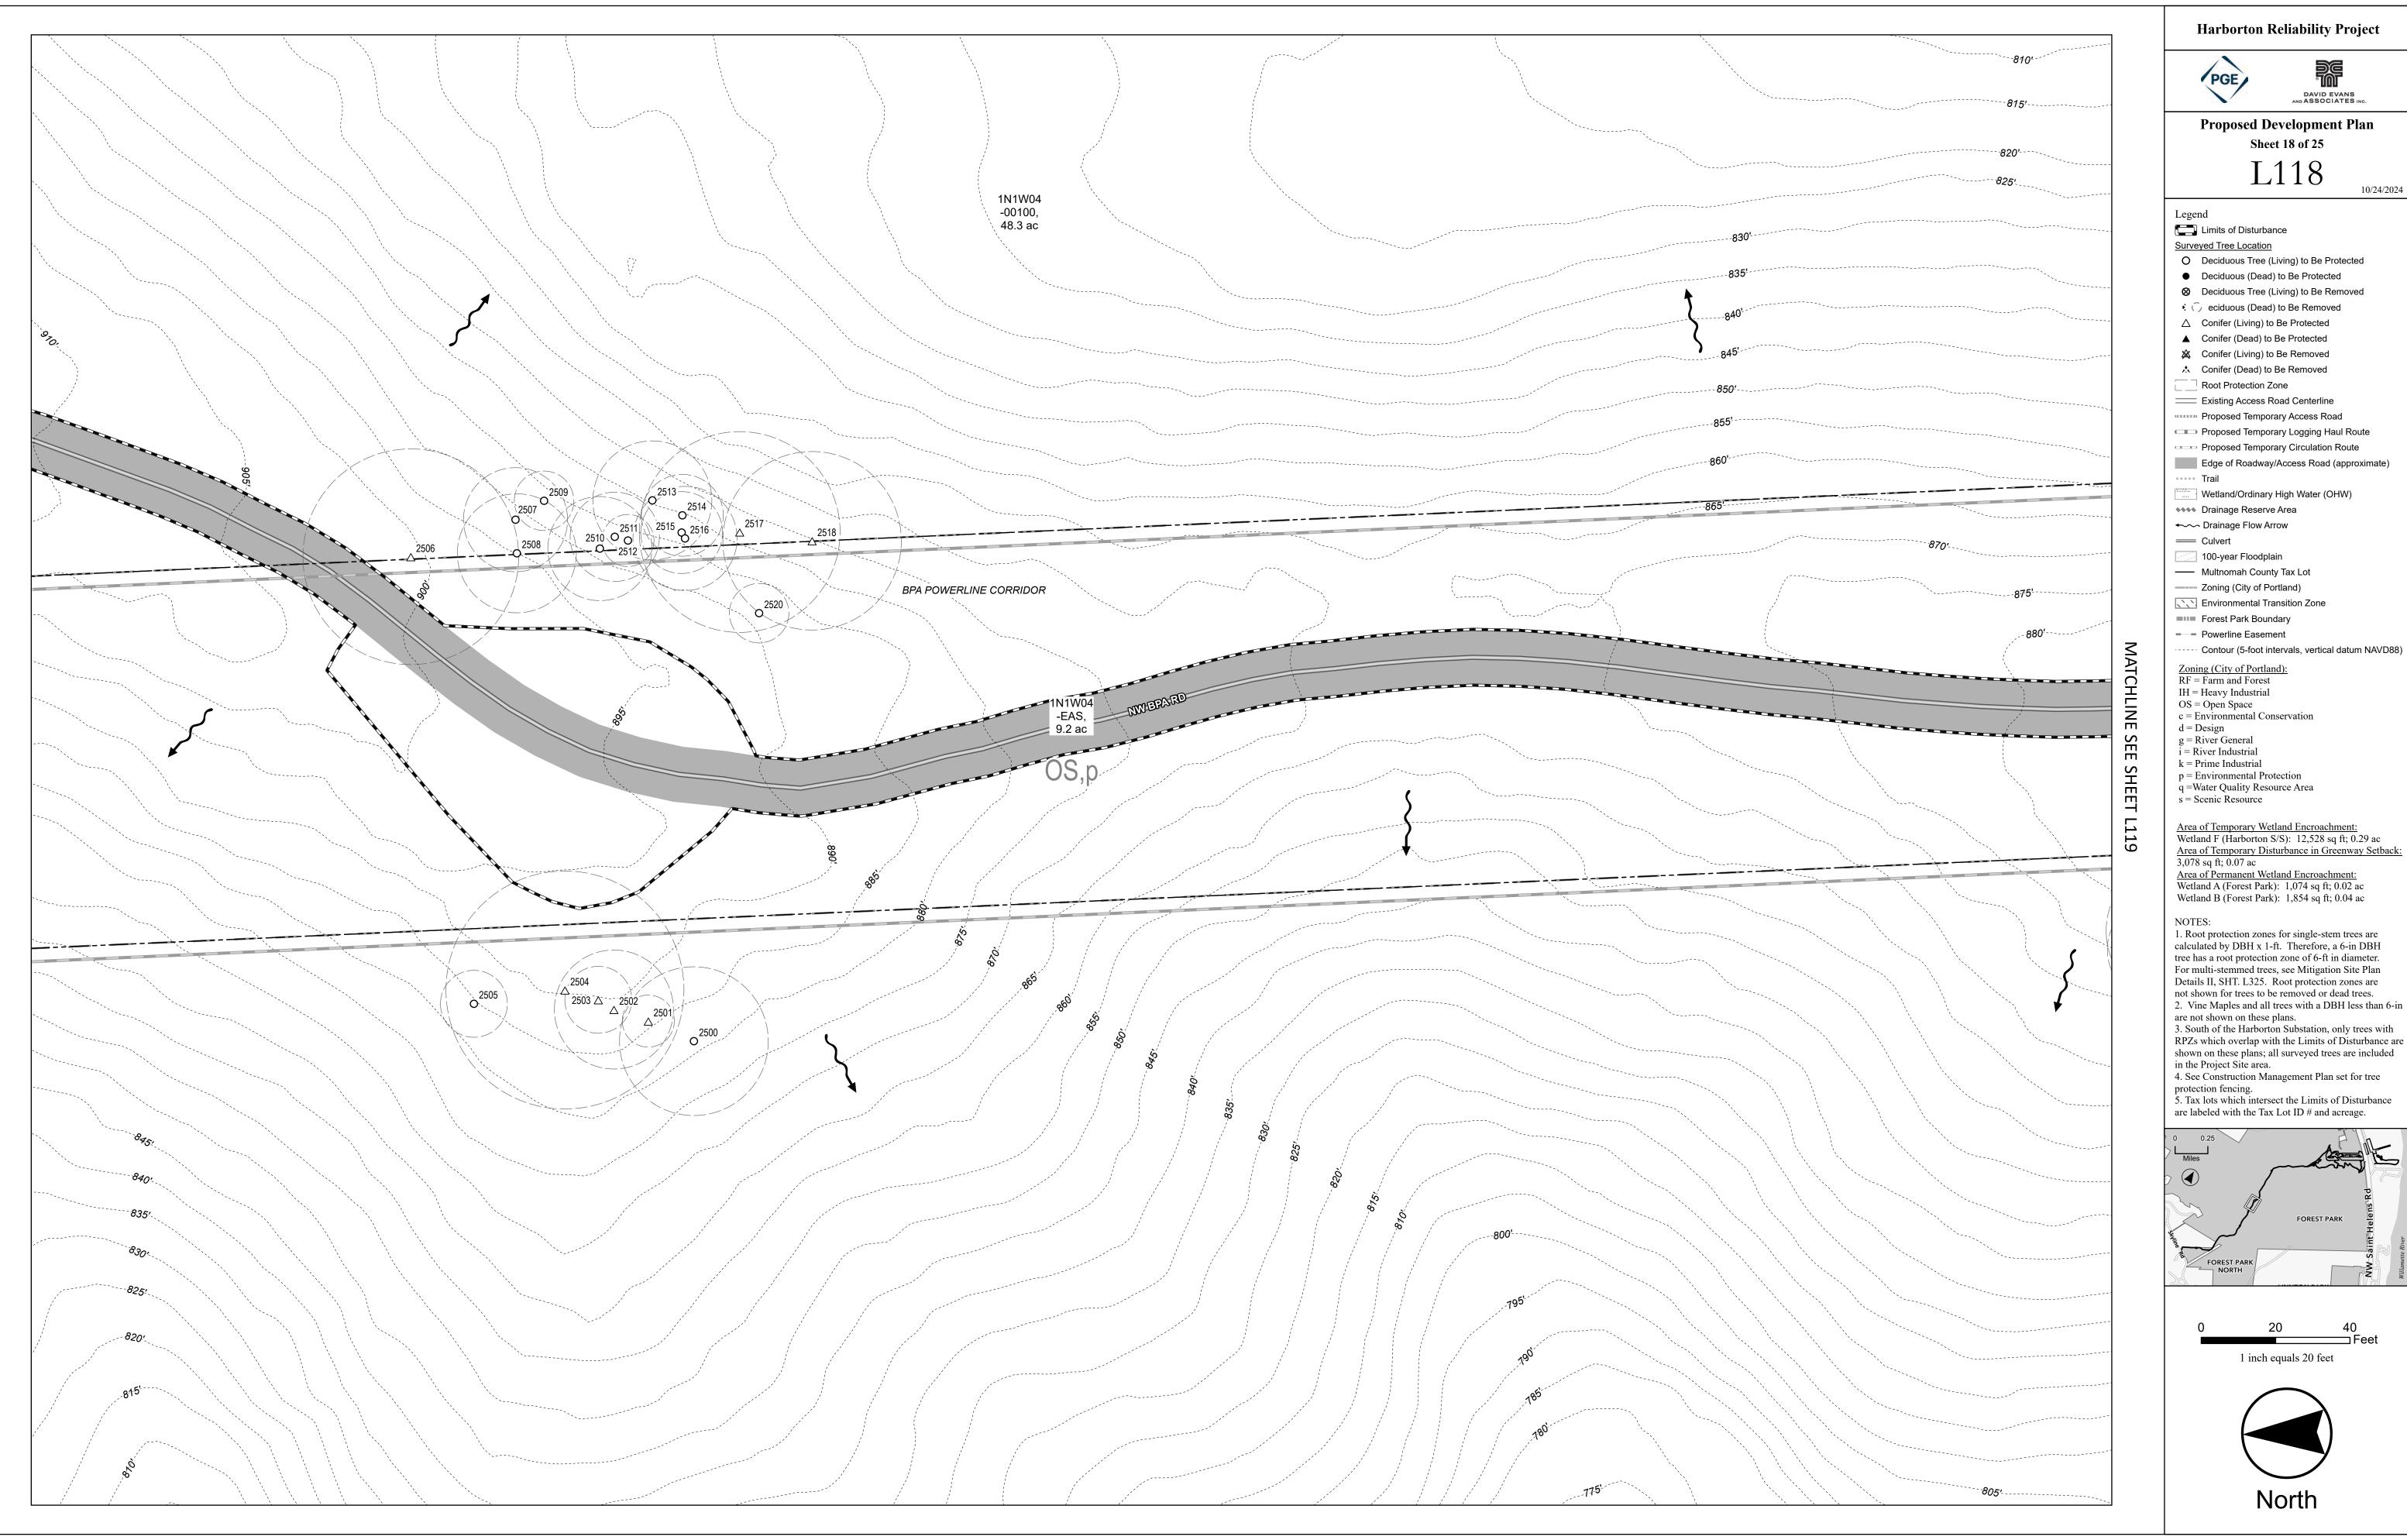


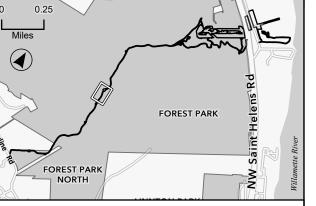

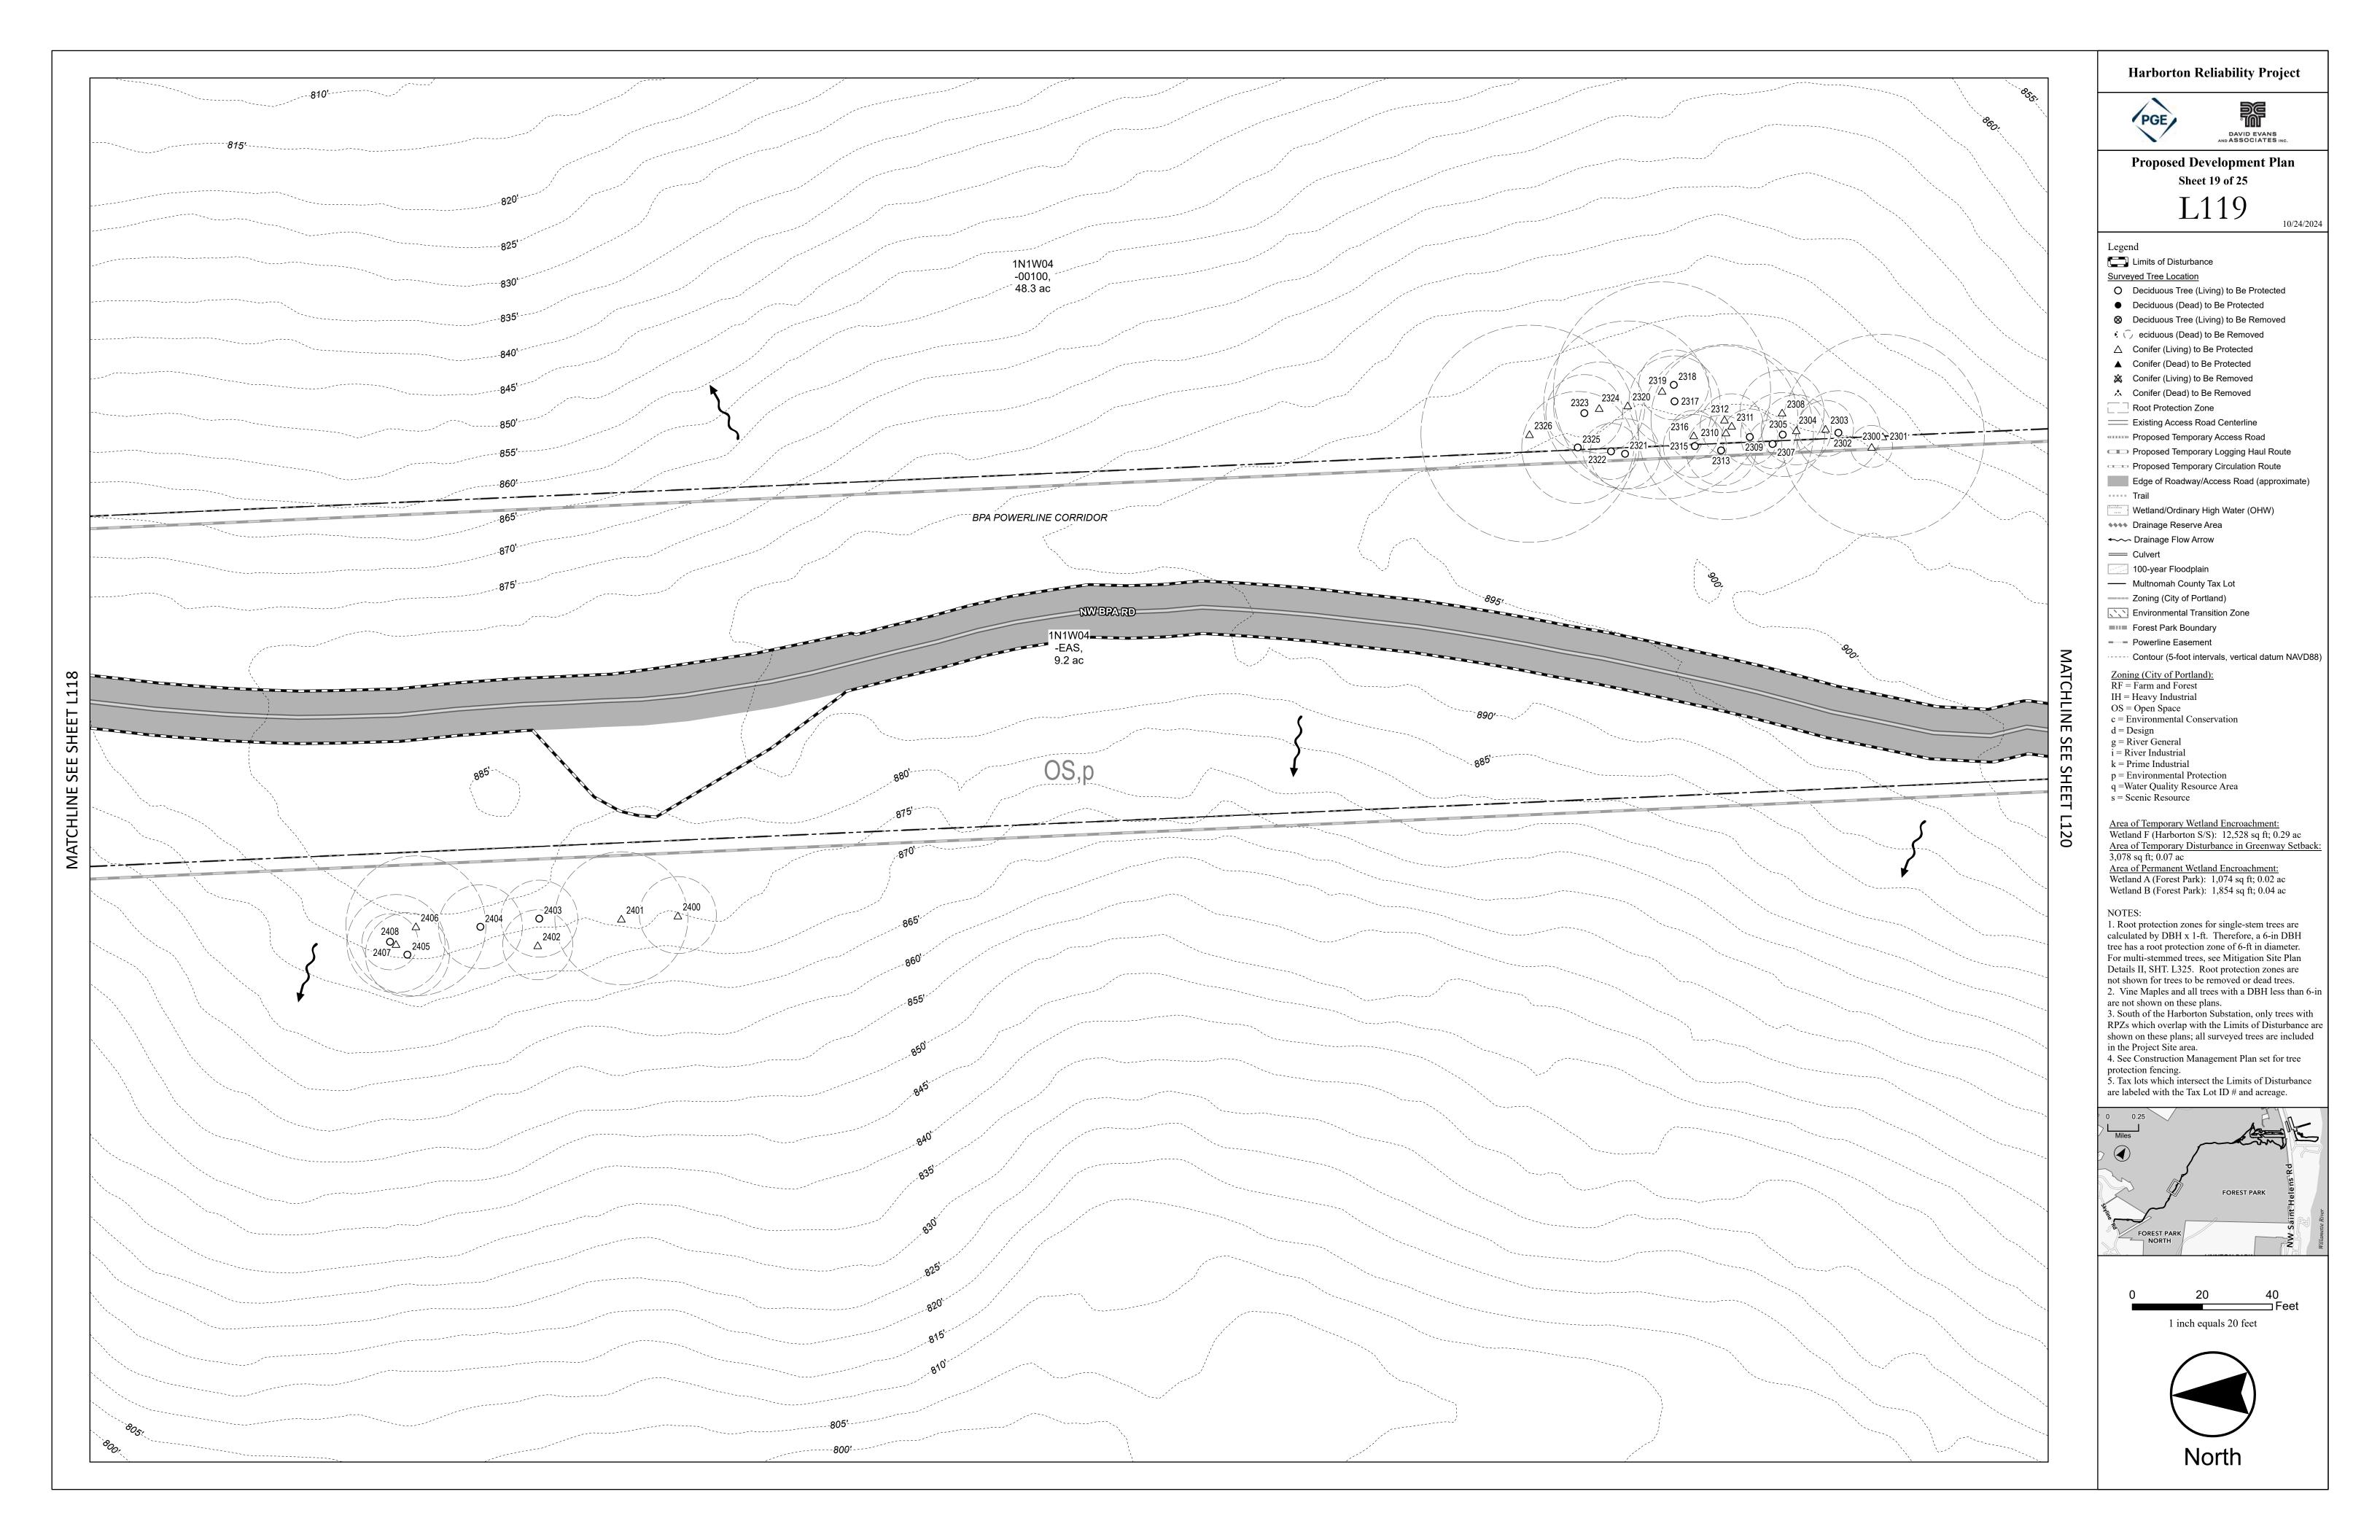

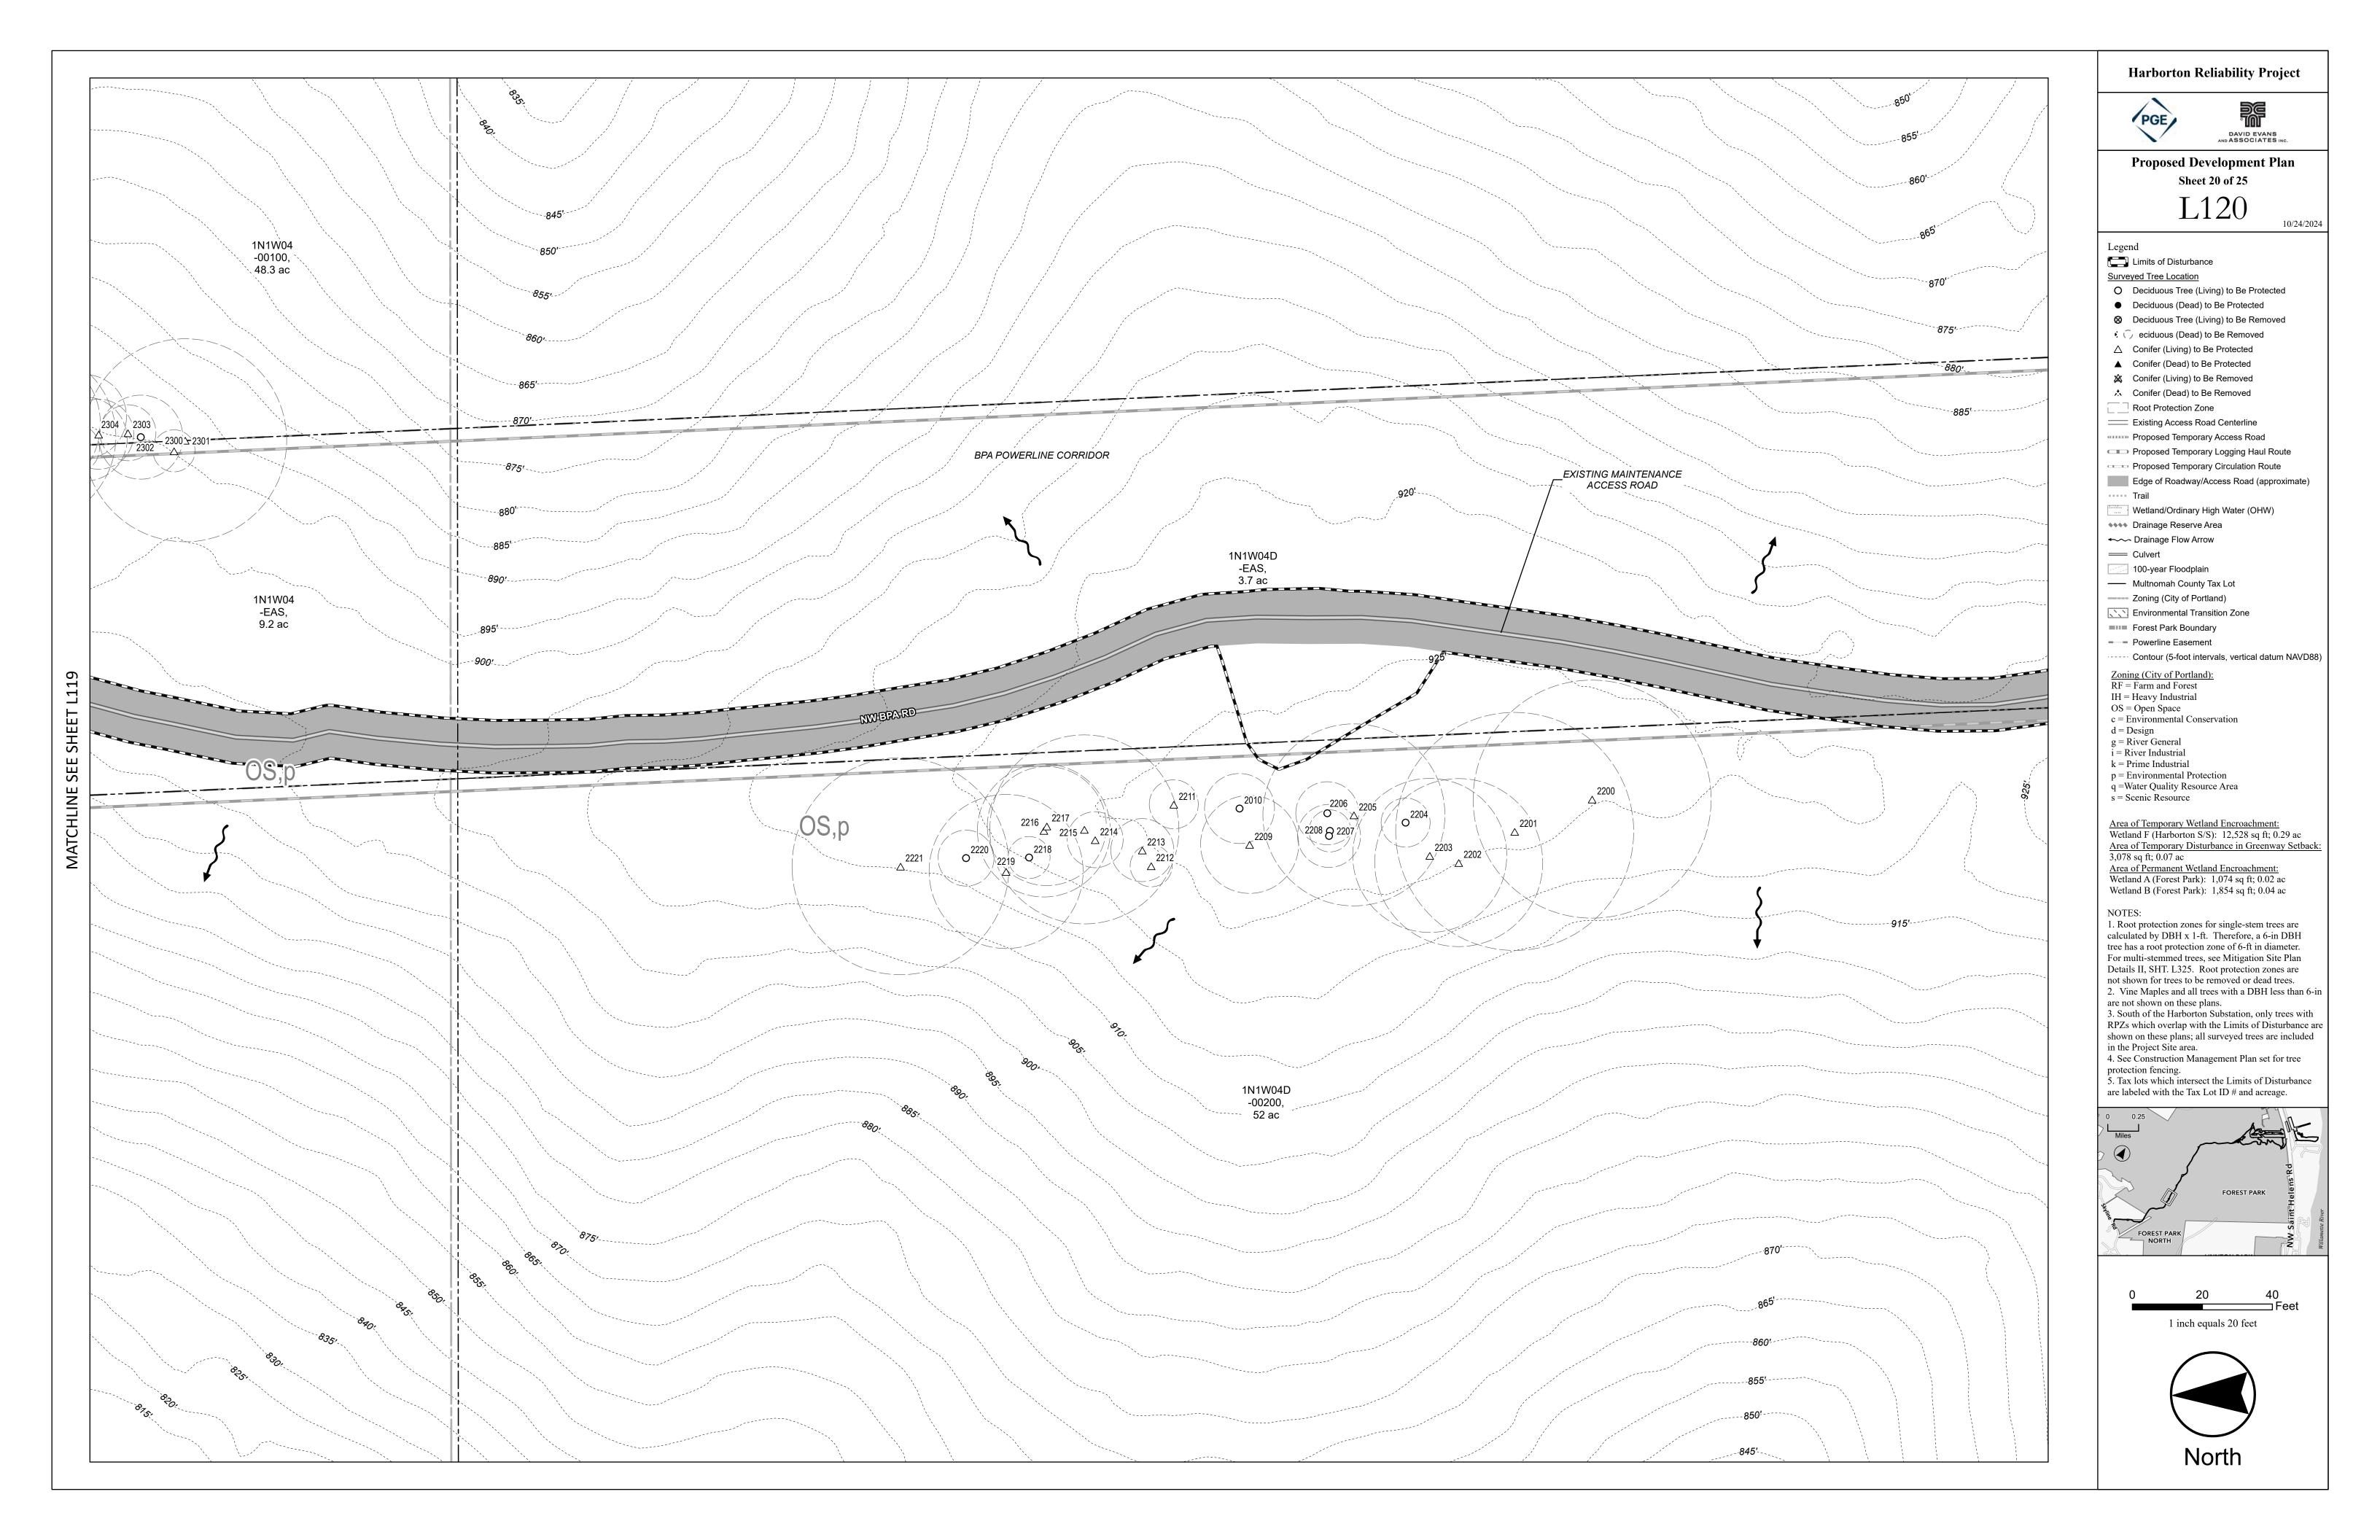


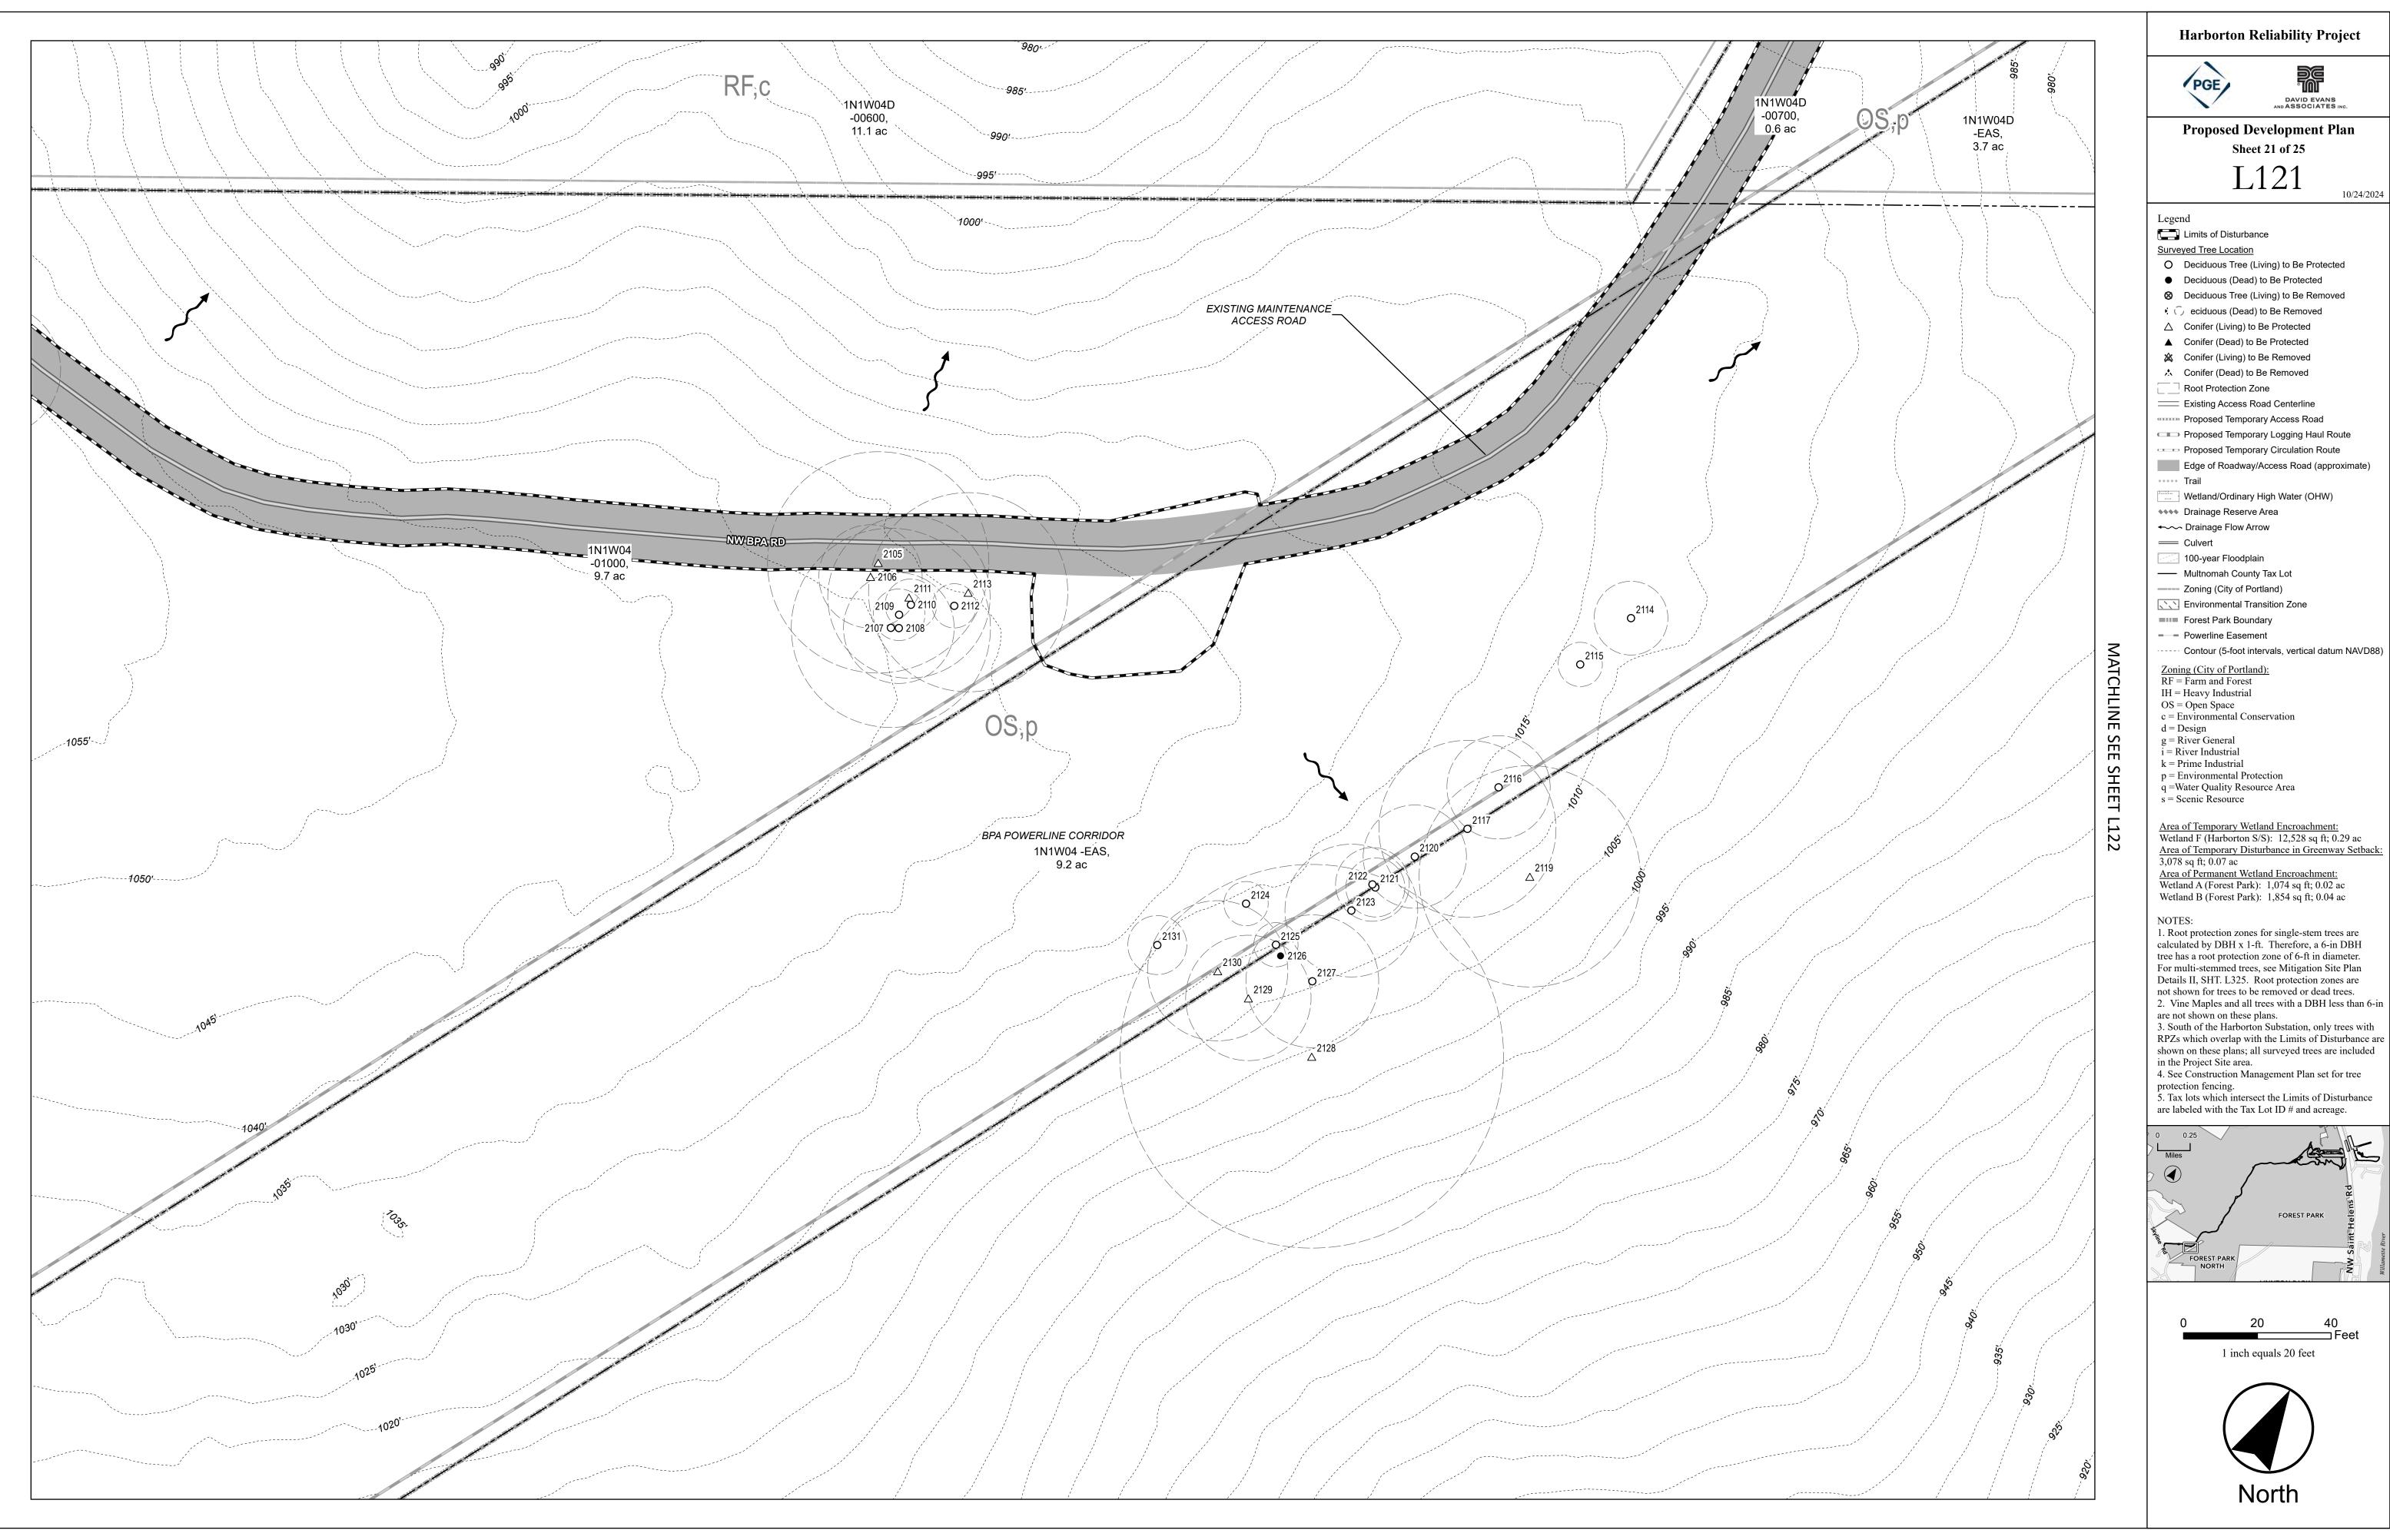

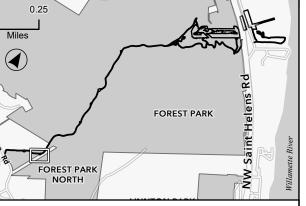





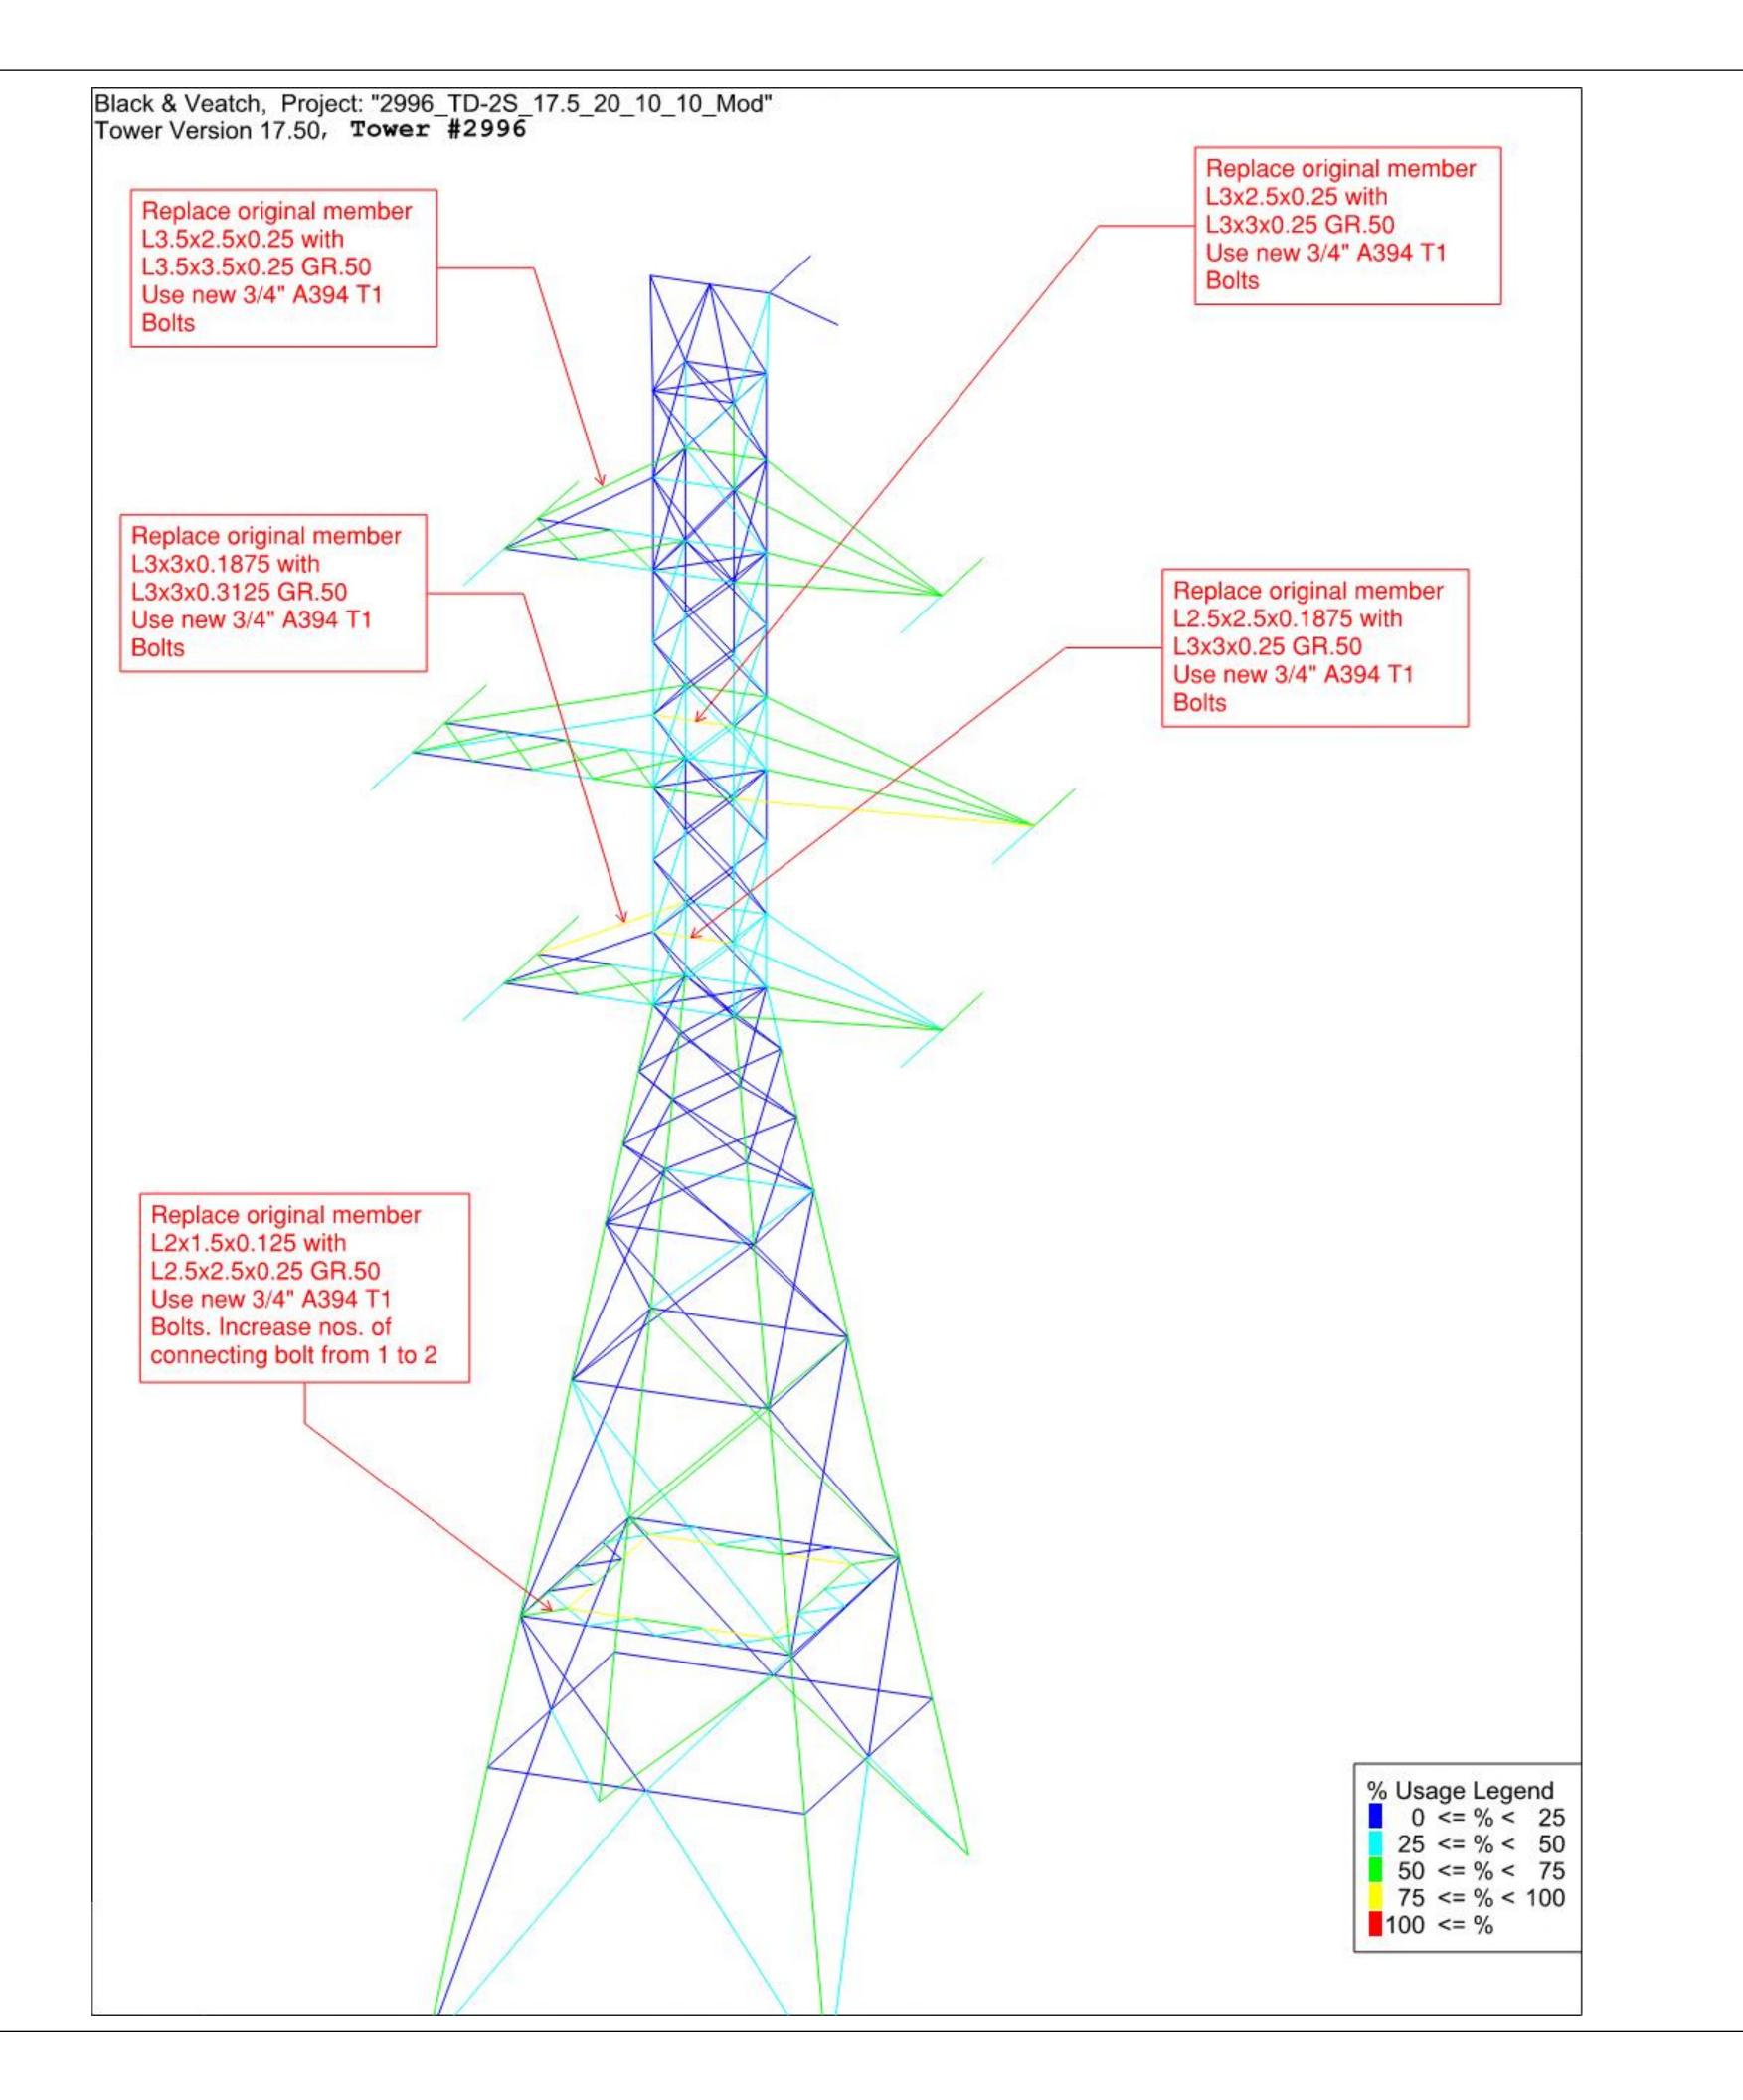

Harborton Reliability Project





Proposed Development Details I Modifications to Lattice Towers Sheet 24 of 25

L124


10/24/2





10/24/2024

Proposed Development Details II New Tubular Steel Pole Structure (Profile) **Sheet 25 of 25** 

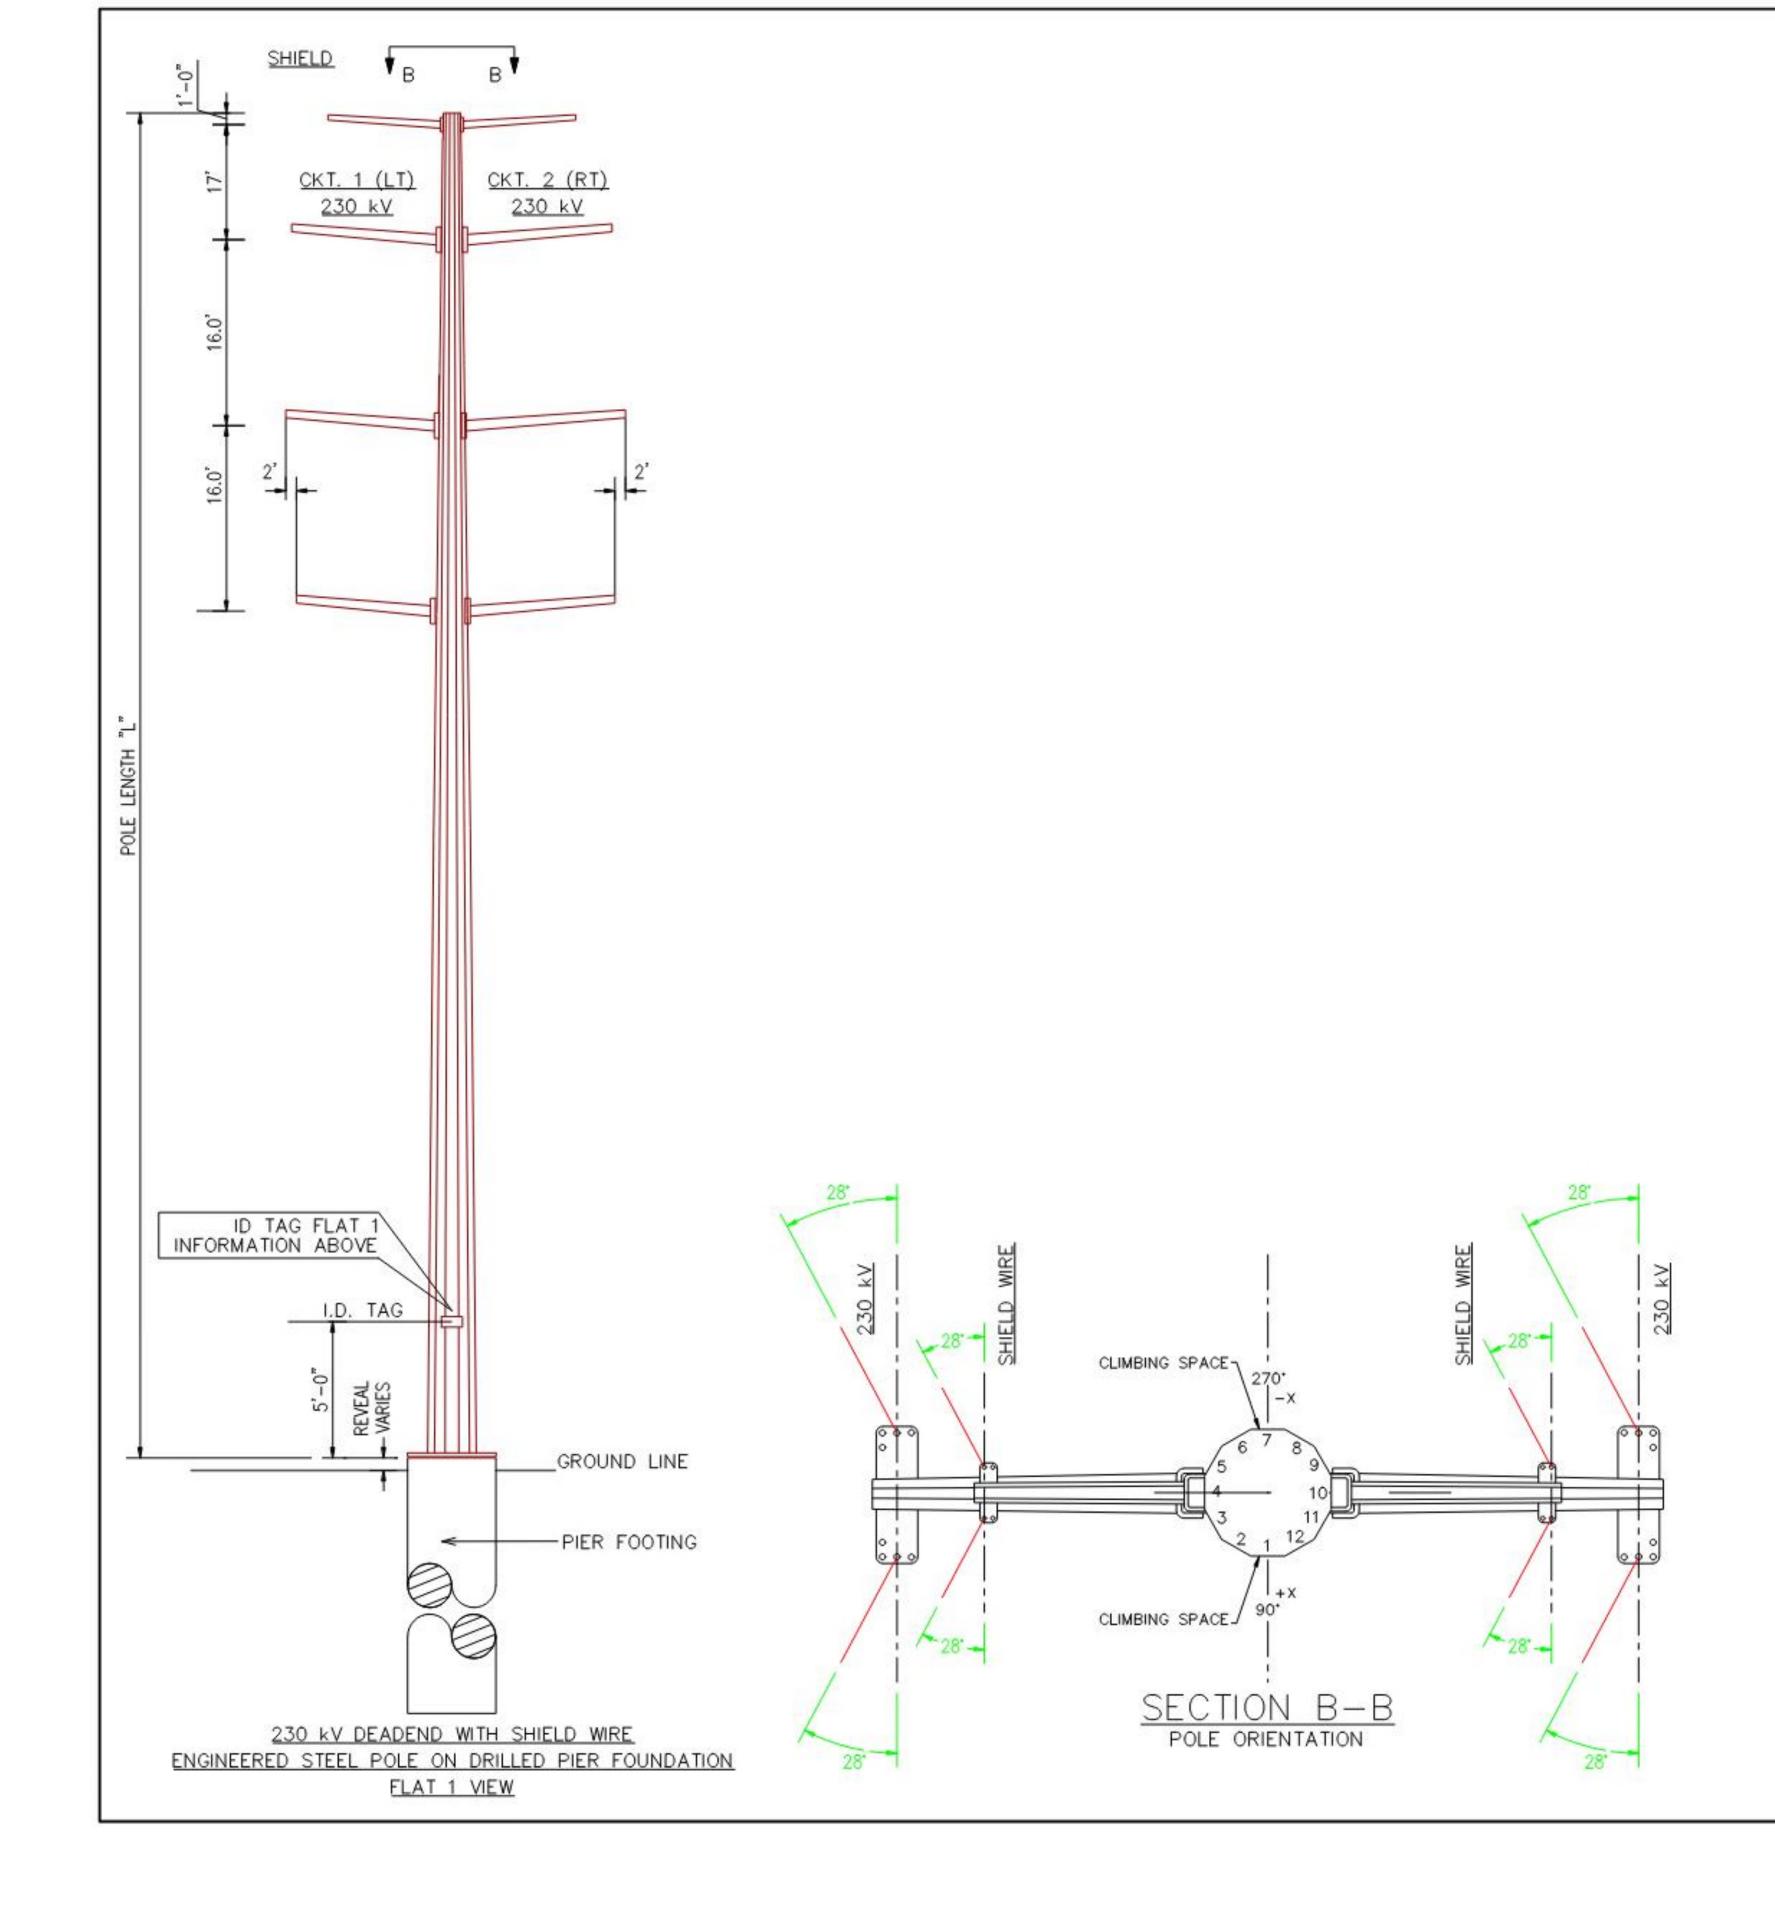

REV	DATE	DESCRIPTION					DSGN	CKD
		PGE ST	TRUCTURE DE	SIGN SP	ECIFICATIONS	S		
DATE:		SCALE: NTS	DRAWING NO. STR-10717			JOB NO. M3405996		
PGE		DEADEND 56-DEG LT, DOUBLE CIRCUIT, 230 kV, SHIELDED  CIRCUIT  LOCATION VARIOUS						
		COUNTY VARIOUS	SECTION(S) VARIOUS					
TRAI	NSMISSION	ENGINEERING SUPERVISOR						SHEET 1 OF 1
SPECIAL 3700	<b>NEERING &amp;</b> LI <b>ZED DESIGN</b> SE 17TH AVE	N ENGINEER		PHONE DRAWN BY			. 0. 1	
PORTLA	AND, OR 97202	© PORTLAND	GENERAL ELECT	RIC CO	- ALL RIGHTS R	ESERV	ED	